
RIVER FIRE MASTER PLAN

THE MALAKOFF HOUSE

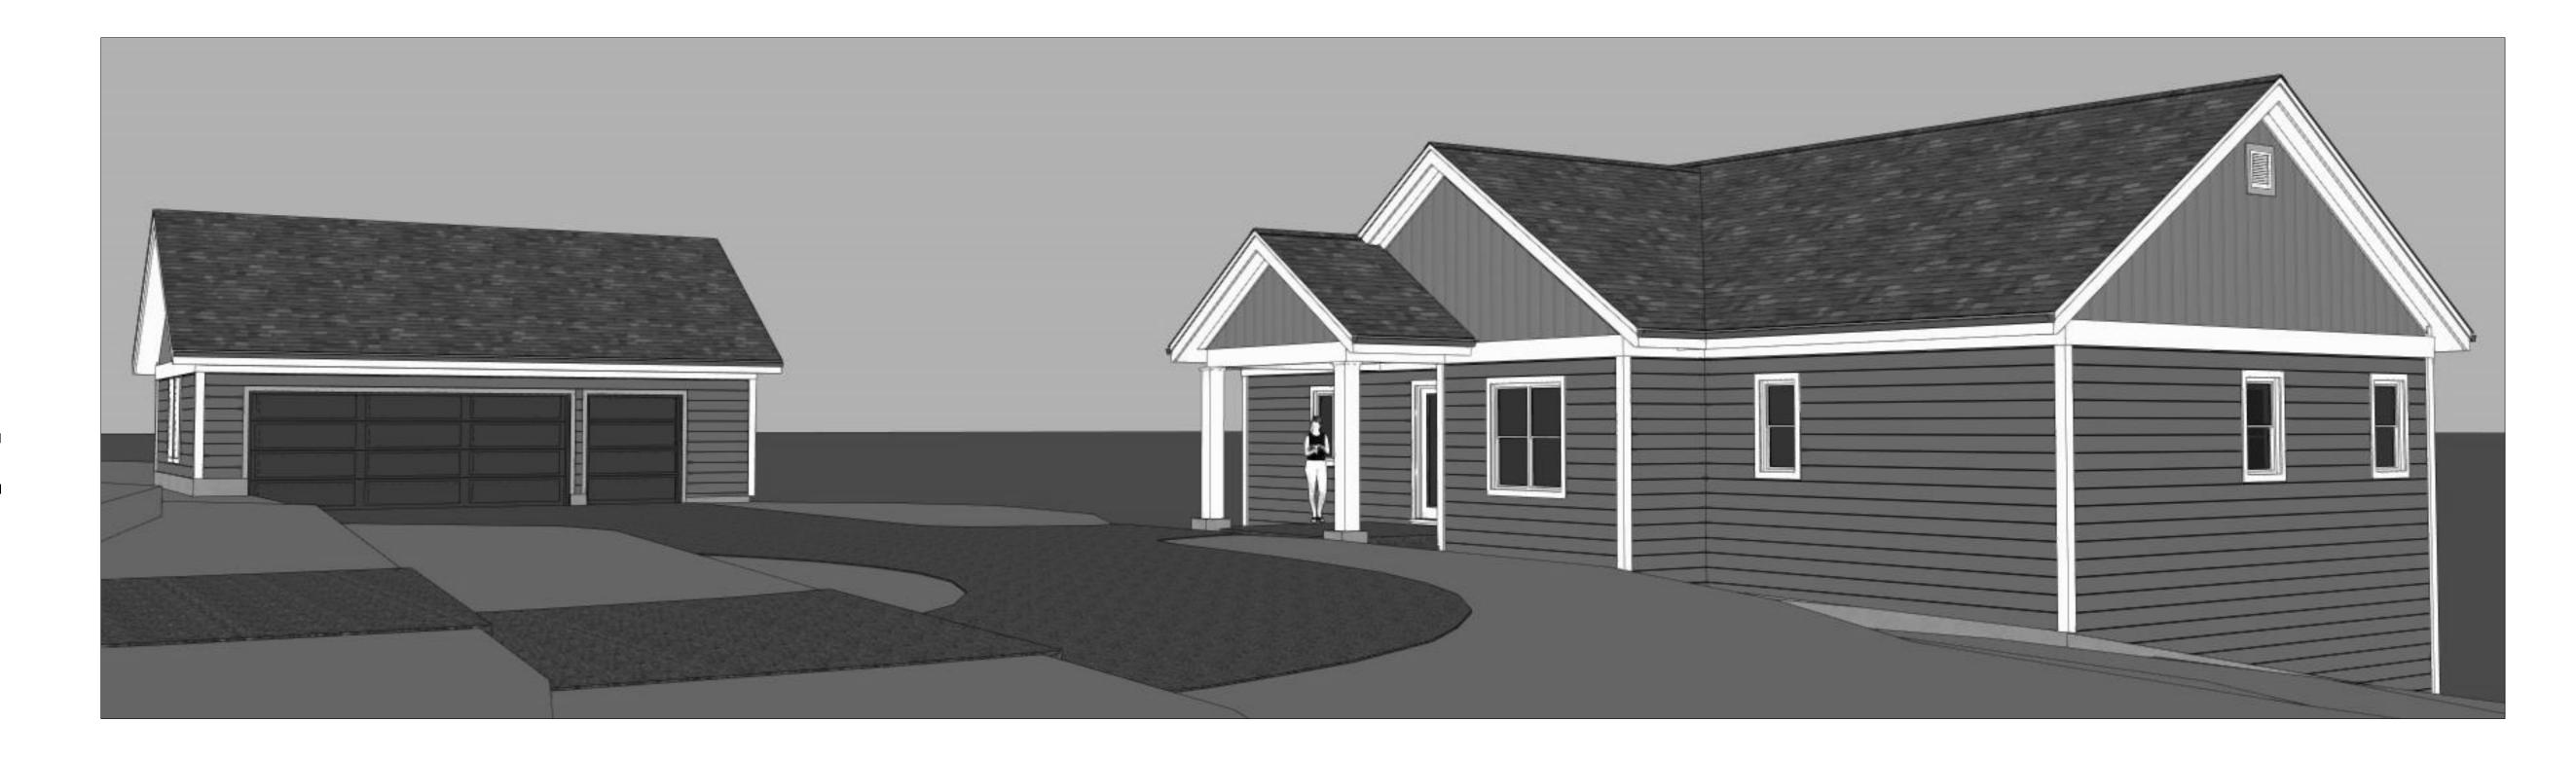

AREA TABULATIONS:

TABULATIONS TO FACE OF STUD / FOUNDATION WALL

MAIN HOUSE: APPROX. 1,556 SQ. FT.

GARAGE / UNCONDITIONED STORAGE: APPROX. 768 SQ. FT.

RAISED DECK: APPROX. 250 SQ. FT.

COVERED PORCH: APPROX. 144 SQ. FT.

ANALYSIS:

OCCUPANCY GROUP: R-3 / U SINGLE FAMILY DWELLING WITH DETACHED GARAGE

TYPE OF CONSTRUCTION: TYPE VB

ALL WORK SHALL COMPLY WITH THE 2019 EDITIONS OF THE C.B.C., C.R.C., C.M.C., C.P.C., C.E.C., C.E.C.S. (ENERGY STANDARDS), AND C.G.B.S.C. (CAL-GREEN) BUILDING STANDARDS, PROPERTY MAINTENANCE CODES, AND ALL APPLICABLE LOCAL ORDINANCES

PROJECT IS LOCATED IN A MODERATE WILDLAND-URBAN INTERFACE AREA AND MUST COMPLY WITH THE PROVISIONS OF THE CRC 2019 (URBAN WILDLAND INTERFACE BUILDING STANDARDS)

ALL REQUIRED EXTERIOR MATERIALS SHALL BE LISTED APPROVED BY 'OSFM' BUILDING MATERIALS LISTING

DESIGN CRITERIA:

SNOW LOAD: 60 LBS/ FT. CLIMATE ZONE: 11
WIND EXPSOSURE: C

DEFERRED SUBMITTALS:

CONSTRUCTION WASTE MANAGEMENT PLAN

PROVIDE A CONSTRUCTION WASTE MANAGEMENT PLAN - RECYCLE AND/OR REUSE A MINIMUM OF 65 PERCENT OF NONHAZARDOUS CONTRUCTION AND DEMOLITION WASTE.

ALSO SEE SHEET A0-1, A0-2, AND CAL-GRN.

SPRINKLER SYSTEM

SPRINKLER SYSTEM DESIGN AND ENGINEERING SHALL BE SUBMITTED FOR APPROVALS PRIOR TO INSTALLATION.

PROVIDE SPRINKLER SYSTEM IN ACCORDANCE
WITH CRC AND NEVADA COUNTY REQUIREMENTS

PROVIDE LETTER FROM THE WATER SERVICE PROVIDER OR A WELL TEST REPORT INDICATING THE AVAILABLE WATER PRESSURE AT THE FIRE SPRINKLER RISER.

GAS PIPING DIAGRAM

DUCT WORK AND GAS LINE SIZING INSTALLED PER THE CA PLUMBING CODE TO BE FIELD VERIFIED BY THE INSPECTOR.

SOLAR ARRAY LAYOUT

SOLAR ROOF LAYOUT AND CALCULATIONS TO BE PROVIDED PRIOR TO PERMIT APPROVAL

INSPECTION REQUIREMENTS:

INSPECTION IS REQUIRED FOR A SOIL FILL, COMPACTION AND GRADING. ALL FILL MATERIAL SHALL BE CLEAN AND FREE OF DEBRIS GREATER THAN 12 INCHED IN DIAMETER. (L-V 19.10 (C) ALL FILL SHALL BE COMPACTED TO A MINIMUM OF 90 PERCENT OF MAXIMUM DENSITY WITH A COMPACTION REPORT ONSITE AT TIME OF INSPECTION.

PRIOR TO ISSUANCE OF A PERMIT, THE APPLICANT SHALL COMPLETE AND SUBMIT A SPECIAL INSPECTION AND TESTING AGREEMENT FORM TO THE BUILDING DEPARTMENT FOR REVIEW FOR ANY REQUIRED SPECIAL INSPECTIONS.

SCOPE OF WORK:

CONSTRUCTION OF SINGLE FAMILY PRIVATE DWELLING AND ALL ASSOCIATED SITE WORK, INCLUDING GARAGE, UTILITIES, PATIOS, AND DRIVEWAY.

SITE ANALYSIS:

SEE SITE PLANS

SHEET INDEX / PROJECT DIRECTORY:

COVER SHEET

ARCHITECTURAL PLANS:

A0-1: GENERAL NOTES

A0-2: NEVADA COUNTY GENERAL NOTES

A0-3: CAL-GREEN CHECKLIST - SHEET 1 A0-4: CAL-GREEN CHECKLIST - SHEET 2

A0-4: CAL-GREEN CHECKLIST - SHEET 2
A0-5: WILDLAND-URBAN INTERFACE CHECKLIST

A1-1: DWELLING FLOOR PLAN

A1-2: GARAGE PLAN AND ELEVATIONS

A1-3: DWELLING / GARAGE ROOF PLANS

A2-1: DWELLING ELEVATIONS
A3-1: DWELLING & GARAGE SECTIONS

E1-1: DWELLING & GARAGE ELECTRICAL FLOOR PLANS

STRUCTURAL/ ENERGY/ GAS PIPING PLANS:

SN1: STRUCTURAL NOTES

S1: FOUNDATION PLANS - HOUSE AND GARAGE

S2: FLOOR FRAMING - HOUSE

S3: ROOF FRAMING - HOUSE AND GARAGE
S4: SHEAR WALL PLAN - HOUSE AND GARAGE

SD1: STRUCTURAL DETAILS

< STRUCTURAL CALCULATIONS >

< TRUSS LAYOUT / CALCULATIONS >

T24: ENERGY CALCULATION

< ENERGY CALCULATIONS >

DESIGNERS:

THOMAS ROMAN ARCHITECTURE 448 COLFAX AVENUE - UNIT D GRASS VALLEY, CA 95945 530-205-8750

FOXLEY DESIGN 13366 ORTON ROAD GRASS VALLEY, CA 95945 530-559-7552

STRUCTURAL ENGINEER:
LINCOLN AND LONG ENGINEERING

568 EAST MAIN STREET GRASS VALLEY, CA 95945

PRE-FAB TRUSS MANUFACTURER:
HOMEWOOD LUMBER / TRUSS

THOMAS ROMAN
Architecture
TR-Architecture.com

530.205.8750





MALAKOFF HOU

MAS

FIRE

RIVER

WRITTEN DIMENSIONS ON THESE DOCUMENTS SHALL HAVE PRECEDENCE OVER SCALED DIMENSIONS.

CONTRACTORS SHALL VERIFY AND BE RESPONSIBLE FOR ALL


DIMENSIONS AND CONDITIONS ON

REMARKS	DATE		
PERMIT SUBMITTAL			
	12-21-21		

ALL FIELD CHANGES TO APPROVED SET OF PLANS SHALL BE FIRST APPROVED BY THE BUILDING DEPARTMENT. FAILURE TO PROVIDE CHANGES TO THE BUILDING DEPARTMENT MAY BE CAUSE FOR THE DEPARTMENT TO ISSUE A STOP WORK NOTICE.

FOLDER	Malakoff
DRAWN BY	TR / JF
FILE	A0-0

COVER SHEET

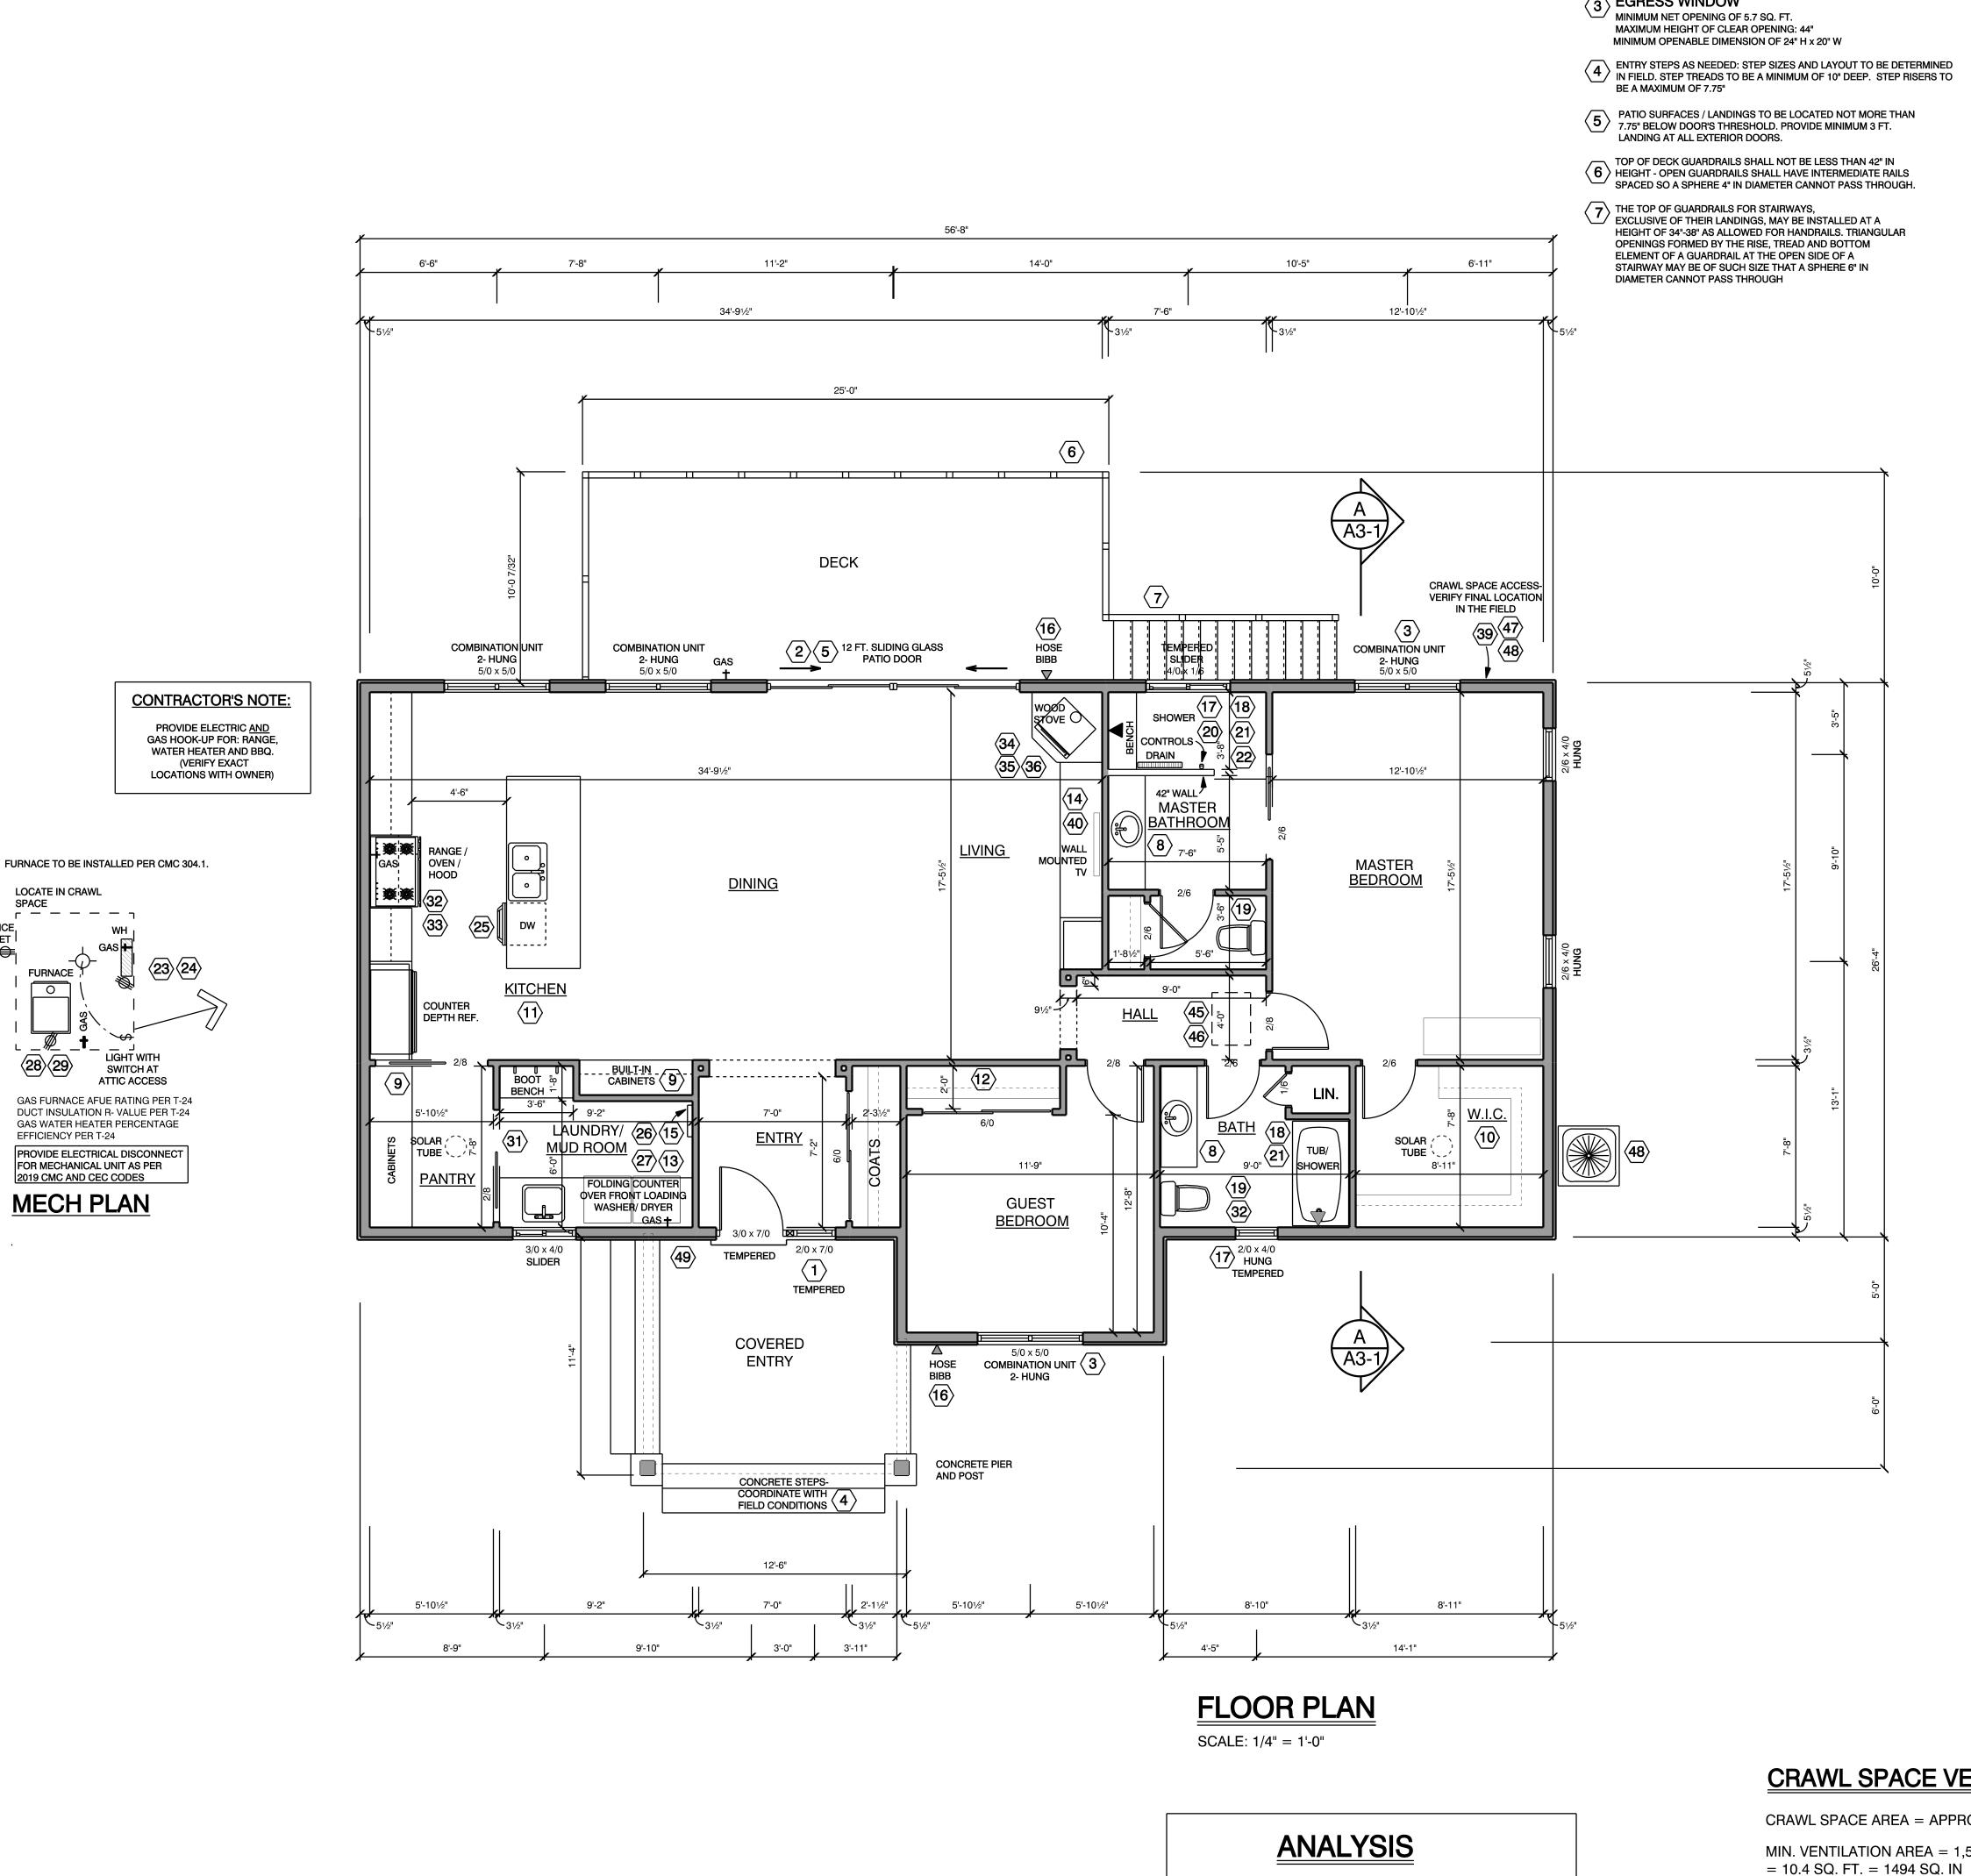

SERVICE OUTLET

FLOOR PLAN NOTES:

TOP PLATE SPLICING: USE A MINIMUM OF 4 FT. LAP SPLICE WITH (10) 16d'S INTO EACH SIDE OF LAP OR USE ST6224 STRAP ACROSS PLATE BREAKS.

ALL INTERIOR DOORS SHALL BE SOLID CORE WOOD DOORS

UNLESS OTHERWISE NOTED PAINT GRADE CLOSET SHELVING SYSTEM DESIGN AND MATERIALS TO BE COORDINATED WITH OWNER APPLIANCES DESIGNED TO BE FIXED IN POSITION SHALL BE

SECURELY FASTENED IN PLACE. SUPPORTS FOR APPLIANCES SHALL BE DESIGNED AND CONSTRUCTED TO SUSTAIN VERTICAL AND HORIZONTAL LOADS WITHIN THE STRESS LIMITATIONS SPECIFIED IN THE BUILDING CODE. ANCHOR STRAPS FOR WATER HEATERS SHALL BE LOCATED WITHIN THE UPPER AND LOWER 1/3 OF ITS VERTICAL DIMENSION, LOWER ANCHOR/STRAP LOCATION TO MAINTAIN A MINIMUM DISTANCE

OF 4" ABOVE THE CONTROLS. (STEEL BRACES REQUIRED, NOT

1 TEMPERED SAFETY GLASS AT DOOR AND WINDOWS OR

PLUMBER'S TAPE.)

- SIDELIGHTS ADJACENT TO DOOR. (2) SLIDING GLASS PATIO DOORS WITH TEMPERED SAFETY GLASS
- (3) EGRESS WINDOW

MINIMUM SHOWER RECEPTACLE SLOPE IS 1/8" PER FOOT

CONTROL FOR MEETING THIS PROVISIONS

- TANKLESS WATER HEATER. INSTALL AND VENT PER MANUFACTURER'S INSTRUCTIONS.
- INSTANTANEOUS WATER HEATERS SHALL HAVE ISOLATION VALVES (24) ON BOTH THE COLD WATER SUPPLY AND THE HOT WATER PIPE LEAVING THE WATER HEATER, AND HOSE BIBBS OR OTHER FITTINGS ON EACH VALVE FOR FLUSHING THE WATER HEATER.
- ALL DISHWASHER WASTE LINES SHALL BE PROVIDED WITH AN APPROVED AIRGAP SEPARATION DEVICE.

8 VANITY BASE CABINET. VERIFY DESIGN AND MATERIALS WITH OWNER.

FOLDING COUNTER OVER FRONT LOADING WASHER AND

FROST FREE HOSE BIBB WITH ANTI-SIPHON DEVICE -- DETERMINE FINAL LOCATION IN THE FIELD.

PROVIDE WALL BLOCKING / BRACING AS REQUIRED FOR

WATER CLOSET STOOL SHALL BE LOCATED IN A CLEAR (19) SPACE NOT LESS THAN 30" IN WIDTH AND HAVE A CLEAR

DRYER. BASE CABINETS. LAUNDRY SINK. WALL MOUNTED

UPPER CABINETS. VERIFY DETAILS AND MATERIALS WITH

TEMPERED SAFETY GLASS AT GLAZING IN SHOWER/ TUB/ SAUNA

SPACE IN FRONT OF THE WATER CLOSET STOOL NOT LESS THAN 24" SECTION 2904 OF THE CBC. WATER CLOSETS MUST

BE ULTRA LOW FLUSH FIXTURES, WHICH USE NO MORE THAN

ALL SHOWER COMPARTMENTS, REGARDLESS OF SHAPE, SHALL

TWENTY-FOUR (1024) SQUARE INCHES AND SHALL ALSO BE

MEASUREMENT SHALL BE MAINTAINED TO A POINT 70" ABOVE

THE SHOWER DRAIN. SHOWERS AND TUB-SHOWER COMBINATIONS SHALL BE PROVIDED WITH INDIVIDUAL CONTROL VALVES OF THE PRESSURE BALANCE OR THE THERMOSTATIC MIXING VALVE TYPE.

HANDLE POSITION STOPS SHALL BE PROVIDED ON SUCH VALVES AND SHALL BE ADJUSTED PER MFR'S INSTRUCTIONS TO DELIVER A MAXIMUM MIXED WATER SETTING OF 120°F (49°C). THE WATER HEATER THERMOSTAT SHALL NOT BE CONSIDERED A SUITABLE

1 HAVE A MINIMUM FINISHED INTERIOR OF ONE THOUSAND

CAPABLE OF ENCOMPASSING A 30" CIRCLE. THIS

COMPARTMENTS LESS THAN 60" ABOVE THE STANDING SURFACE WITHIN THE COMPARTMENT AND WITHIN 60 INCHES HORIZONTALLY

 $\langle 9 \rangle$ materials to be coordinated with owner

(11) KITCHEN CABINET DESIGN AND MATERIALS

(12) SHELF AND POLE

(14) BUILT-IN MEDIA CENTER

(15) BUILT-IN FOLD-DOWN IRON BOARD.

OF THE WATER'S EDGE.

2/ INSTALLATION OF GRAB BARS

1.28 GALLONS PER FLUSH.

20 TILE SHOWER ENCLOSURE

PAINT GRADE PANTRY CABINETS AND SHELVING DESIGN AND

- WASHER AND DRYER BY OWNER
- DRYER SHALL BE VENTED THROUGH-ROOF OR WALL TO THE (27) OUTSIDE AS PER MANUFACTURER'S RECOMMENDATIONS -- PROVIDE BACK-DRAFT DAMPER (SCREEN NOT PERMITTED) -- CLOTHES DRYER VENT SHALL BE OF METAL AND SHALL HAVE SMOOTH INTERIOR SURFACES AND A MINIMUM OF A 4-INCH DIAMETER -- APPROVED FLEXIBLE DUCT CONNECTORS NOT MORE THAN 6' IN LENGTH AND NOT CONCEALED WITHIN CONSTRUCTION -- UNLESS OTHERWISE PERMITTED OR REQUIRED BY THE DRYER MANUFACTURER'S SPECIFICATIONS, DOMESTIC DRYER MOISTURE EXHAUST DUCTS SHALL NOT EXCEED A TOTAL COMBINED HORIZONTAL AND VERTICAL LENGTH OF 14' INCLUDING TWO 90-DEGREE ELBOWS. TWO FEET SHALL BE DEDUCTED FOR EACH 90-DEGREE ELBOW IN EXCESS OF TWO
- MIN. 30" x 30" CLEAR MAINT. SPACE AT HWH AND FURNACE - VERIFY ROOM DIMENSIONS W/ EQUIPMENT
- GAS FURNACE AFUE RATING PER T-24 DUCT INSULATION R- VALUE PER T-24
- (30) A/C COND. UNIT ON CONCRETE PAD CONCRETE PAD SHALL BE MINIMUM 3" THICK - VERIFY FINAL LOCATION IN FIELD -- A/C COND SEER RATING PER T-24

GAS WATER HEATER PERCENTAGE EFFICIENCY PER T-24

- PROVIDE COMBUSTION AIR WITH HIGH AND LOW LOUVERED VENTS (100 SQ. IN. MIN.) IN DOOR TO PROVIDE MAKEUP AIR
- REQUIREMENTS FOR THE DRYER. EXHAUST OPENINGS TERMINATING OUTDOORS SHALL BE COVERED WITH A 1/4"-1/2" CORROSIVE CORROSION RESISTANT MESH (EXCEPT CLOTHS
- PROVIDE A KITCHEN HOOD VENTED DIRECTLY TO THE OUTSIDE PROVIDING A MINIMUM OF 100 C.F.M. PER THE CMC AND ENERGY CODE. THE FAN MUST BE LISTED AT 3 SONE OR LESS FOR NOISE. THE RATING MUST BE BASED ON A WATER COLUMN OF .25 OR GREATER. (IF THE FAN EXHAUSTS IN EXCESS OF
- 400 C.F.M., THE 3 SONE IS NOT REQUIRED.) U.L. LISTED WOOD BURNING FIRE-BOX. INSTALL UNIT AND VENT AS PER LISTING, MFR'S INSTRUCTIONS AND ALL APPLICABLE CODES. ALL SOLID FUEL BURNING APPLIANCES MUST BE E.P.A. PHASE II CERTIFIED AND MEET CALIF. ENERGY
- (35) RAISED TILE HEARTH DIMENSIONS PER MFR.

REQUIREMENTS.

- REFER TO MANUFACTURER'S SPECIFICATIONS FOR HEARTH REQUIREMENTS. (IF NO SPECIFICATIONS PROVIDED BY THE MANUFACTURER, HEARTHS SHALL EXTEND AT LEAST 16" FROM THE FRONT OF AND AT LEAST 8" BEYOND EACH SIDE OF THE FIREBOX. WHERE THE FIREBOX OPENING IS 6 SQUARE FEET OR LARGER, THE HEARTH EXTENSION SHALL EXTEND AT LEAST 20" IN FRONT AND AT LEAST 12" BEYOND EACH SIDE)
- UNDER-FLOOR AREA WITH STORAGE, FUEL-FIRED OR ELECTRIC-POWERED EQUIPMENT WITH LESS THAN 2X10 SOLID JOISTS SHALL BE PROTECTED ON THE UNDERSIDE BY HALF-INCH SHEETROCK OR A SPRINKLER SYSTEM
- IF ATTIC HAS A VERTICAL HEIGHT OF MORE THAN 30", PROVIDE A READILY ACCESSIBLE ACCESS OPENING NOT LESS THAN 22" X 30" FOR EMERGENCY ENTRY TO ATTIC, MINIMUM 30" UNOBSTRUCTED HEADROOM IN THE ATTIC SPACE SHALL BE PROVIDED AT OR ABOVE THE ACCESS OPENING. VERIFY FINAL LOCATION IN THE FIELD.
- ATTIC ACCESS TO BE WEATHER-STRIPPED TO PREVENT AIR LEAKAGE. CRAWL SPACE ACCESS TO BE 36" x 80". MINIMUM OF 30" x 20"
- REQUIRED WITH MECHANICAL EQUIPMENT LOCATED IN THE CRAWL WALL MOUNTED FLAT SCREEN TV - PROVIDE BLOCKING AS
- REQUIRED FOR MOUNTING HARDWARE IF ATTIC HAS A VERTICAL HEIGHT OF MORE THAN 30", PROVIDE A READILY ACCESSIBLE ACCESS OPENING NOT LESS THAN

22" x 30" FOR EMERGENCY ENTRY TO ATTIC, MINIMUM

- 30" UNOBSTRUCTED HEADROOM IN THE ATTIC SPACE SHALL BE PROVIDED AT OR ABOVE THE ACCESS OPENING. ATTIC ACCESS TO BE WEATHER-STRIPPED TO PREVENT AIR LEAKAGE.
- ATTIC ACCESS SHALL HAVE PERMANENTLY ATTACHED INSULATION USING ADHESIVE OR MECHANICAL FASTENERS.
- GAS FURNACE AFUE RATING PER T-24 DUCT INSULATION R- VALUE PER T-24 GAS WATER HEATER PERCENTAGE EFFICIENCY PER T-24 AIR CONDITIONER SEER RATING PER T-24
- UNDER-FLOOR AREA WITH STORAGE, FUEL-FIRED OR ELECTRIC-POWERED EQUIPMENT WITH LESS THAN 2X10 SOLID JOISTS SHALL BE PROTECTED ON THE UNDERSIDE BY HALF-INCH SHEETROCK OR A SPRINKLER SYSTEM
- SIX INCH HIGH CONTRASTING HOUSE NUMBERS, DETERMINE FINAL LOCATION IN THE FIELD.

CRAWL SPACE VENTILATION ANALYSIS

CRAWL SPACE AREA = APPROX. 1,556 SQ. FT.

MIN. VENTILATION AREA = 1,556 / 150

FOUNDATION WALL VENTS:

MAIN HOUSE: APPROX. 1,556 SQ. FT.

RAISED DECK: APPROX. 250 SQ. FT.

COVERED PORCH: APPROX. 144 SQ. FT.

GARAGE: APPROX. 768 SQ. FT.

WALL VENTS TO MASCO CT 68COMBO FOUNDATION VENTS NET FREE NENTILATION AREA OF 100 SQ. IN. PER VENT

PROVIDE MINIMUM 15 FOUNDATION VENTS - VERIFY FINAL LOCATIONS IN FIELD

= APPROX. 1,500 SQ. IN. N.F.V.A.







WRITTEN DIMENSIONS ON THESE DOCUMENTS SHALL HAVE PRECEDENCE OVER SCALED DIMENSIONS.

CONTRACTORS SHALL VERIFY AND BE RESPONSIBLE FOR ALL DIMENSIONS AND CONDITIONS ON THE JOB.

RMIT SUBMITTAL		
12-21-21		

ALL FIELD CHANGES TO APPROVE SET OF PLANS SHALL BE FIRST APPROVED BY THE BUILDING DEPARTMENT. FAILURE TO PROVIDE CHANGES TO THE **BUILDING DEPARTMENT MAY BE** CAUSE FOR THE DEPARTMENT TO ISSUE A STOP WORK NOTICE.

DRAWN BY

DWELLING FLOOR PLAN

EXTERIOR FINISHES

HARDIE-PLANK (OR EQUAL) HORIZONTAL SIDING - PAINTED. INSTALL OVER TYVEK OR SIMILAR WATER RESISTIVE BARRIER

SIDING - PAINTED. INSTALL OVER TYVEK OR SIMILAR WATER

PER CRC R703.2. BOARD AND BATT SIDING: HARDIE-PLANK (OR EQUAL) BOARD AND BATT PATTERN

RESISTIVE BARRIER PER CRC R703.2. TRIMS, FRIEZE BOARD AND BELLY BAND: 5/4 CHOICETRIM

PAINT ALL SURFACES.

(OR EQUAL) TRIMS. EXTERIOR WINDOW AND DOOR TRIMS: - TRADITIONAL EXTERIOR WINDOW AND DOOR TRIMS,

WITH SLOPING SILL (WITH DRIP), AND APRON. - FLASHING TO LAP WINDOW AND DOOR TRIMS AT HEAD. - PRIME AND PAINT EAVES: EXPOSED EAVE WITH VENTED FRIEZE BLOCK. PRIME AND

FACIA: 5/4 CHOICETRIM (OR EQUAL) FASCIA. PRIME / PAINT ALL EXTERIOR MATERIALS: - BID TO ASSUME TWO BASE COLORS WITH SEPARATE TRIM

- COLORS TO MATCH COLORS OF EXISTING STRUCTURES.

WINDOWS AND DOORS

- COLORS AS APPROVED BY OWNER.

COLOR TO BE SELECTED BY OWNER.

WINDOWS: HIGH QUALITY VINYL WINDOWS WITH DUAL PANE / LOW-E GLAZING. PROVIDE GRID PATTERNS AS INDICATED - SEE PLANS AND ELEVATIONS.

GARAGE DOORS TO BE INSULATED METAL WITH SIMULATED PANEL LOOK. EACH GARAGE DOOR TO BE PROVIDED WITH AUTOMATIC GARAGE DOOR

GARAGE MAN-DOOR SHALL BE WOOD OR COMPOSITE WITH TEMPERED

DOOR HARDWARE TO BE SELECTED BY OWNER. ASSUME HIGH QUALITY LEVER TYPE DOOR HARDWARE WITH RUSTIC FINISH.

ROOF TO BE "CLASS A" FIBERGLASS COMPOSITION ROOF SHINGLES. MANUFACTURER AND COLOR TO BE SELECTED BY OWNER. INSTALL OVER 30# FELT UNDERLAYMENT PER CRC R905.1.1.


STANDARD PREFINISHED METAL GUTTERS AND DOWNSPOUTS.


DOWNSPOUTS SHALL BE CONNECTED TO UNDERGROUND PLASTIC DRAINPIPES, SLOPED TO DAYLIGHT.


"SUN TUNNEL" SOLAR TUBES AS INDICATED


GABLE END

NOTE: SIDING AT GABLE ENDS SHALL BE EITHER NON-COMBUSTIBLE MATERIAL, IGNITION RESISTANT MATERIAL, OR ONE LAYER OF 5/8" TYPE X EXTERIOR RATED GYPSUM SHEATHING APPLIED BEHIND AN EXTERIOR COVERING, OR AN ASSEMBLY APPROVED BY OSFM BML.

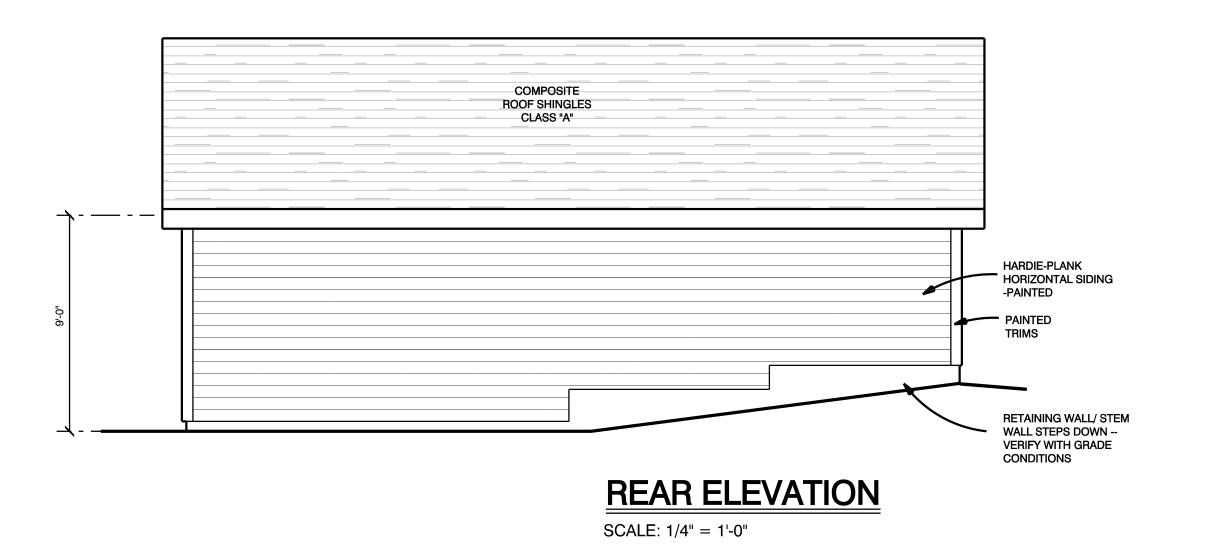

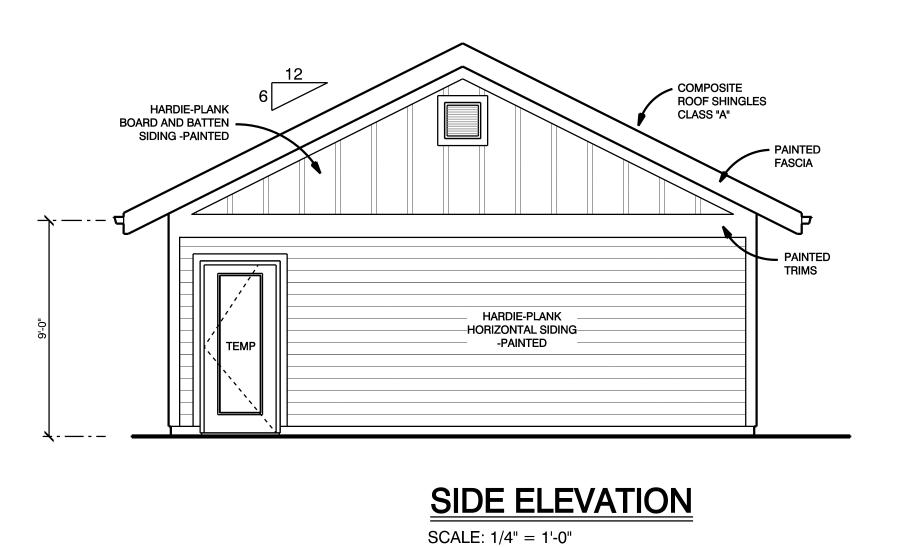

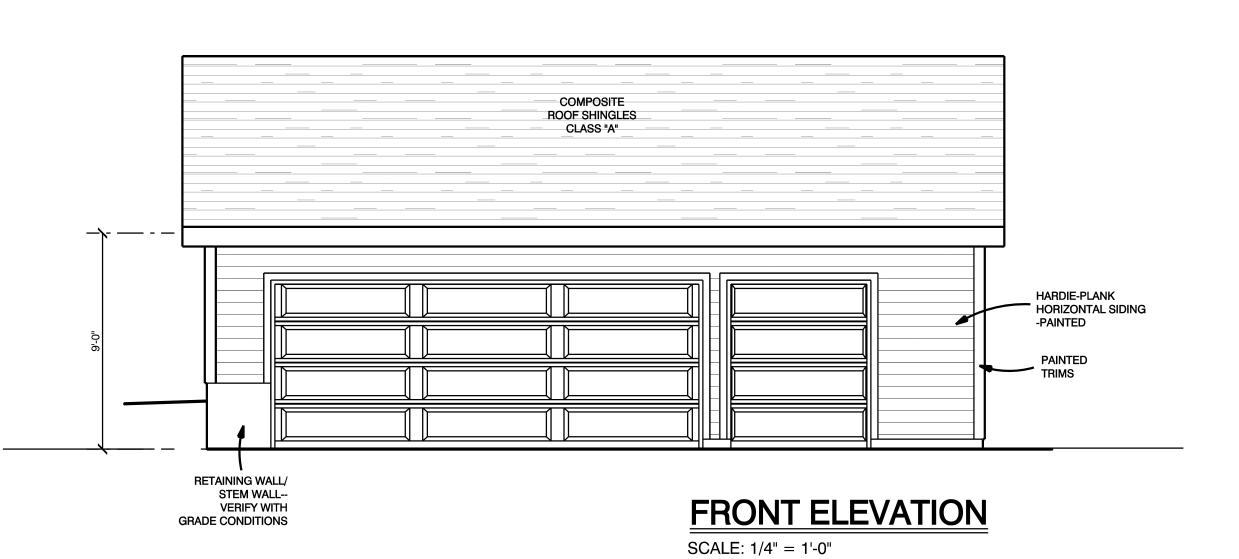

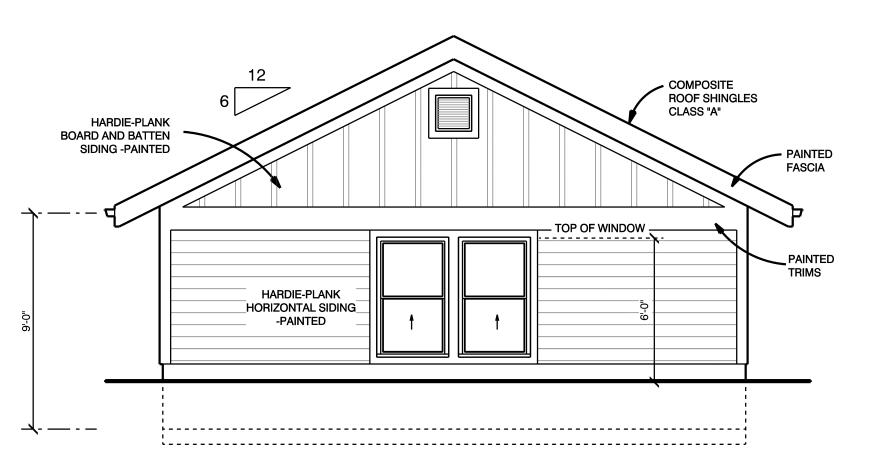

SIDE ELEVATION

SCALE: 1/4" = 1'-0"





GARAGE PLAN NOTES:

IF ATTIC HAS A VERTICAL HEIGHT OF MORE THAN 30", PROVIDE A READILY ACCESSIBLE ACCESS OPENING NOT

OPENING. VERIFY FINAL LOCATION IN THE FIELD.

ELECTRIC CHARGING STATION:
(FINAL LOCATION TO BE DETERMINED IN THE FIELD)

OF NOT LESS THAN NOMINAL 1 INCH DOAMETER

CONCRETE STEM WALL TO 6" ABOVE GRADE AT GARAGE

BACKUP FOR EMERGENCY OPERATION

32'-0"

STORAGE SHELVING BY OWNER

18/0 x 7/0 GARAGE DOOR

18'-0"

32'-0"

LESS THAN 22" X 30" FOR EMERGENCY ENTRY TO ATTIC,

MINIMUM 30" UNOBSTRUCTED HEADROOM IN THE ATTIC

SPACE SHALL BE PROVIDED AT OR ABOVE THE ACCESS

ATTIC ACCESS TO BE WEATHER-STRIPPED TO PREVENT AIR LEAKAGE.

INSTALL A LISTED RACEWAY TO ACCOMMODATE 208/240 VOLT BRANCH CIRCUIT

THE RACEWAY SHALL ORIGINATE AT THE MAIN SERVICE OR SUBPANEL AND

SHALL TERMINATE IN A LISTED CABINET, BOX OR ENCLOSURE IN CLOSE PROXIMITY TO THE PROPOSED LOCATION OF THE EV CHARGER. RACEWAYS

ARE REQUIRED TO BE CONTINUOUS AT ENCLOSED, INACCESSIBLE OR

SHALL BE PERMANENTLY AND VISIBLY MARKED AS " EV CAPABLE".

CONCEALED AREAS AND SPACES. THE RACEWAY TERMINATION LOCATION

THE SERVICE PANEL AND/OR SUBPANEL SHALL PROVIDE CAPACITY TO INSTALL

DEVICE. THE SERVICE PANEL OR SUBPANELT SHALL IDENTIFY THE OVERCURRENT

42

SLOPE GARAGE CONCRETE SLAB

- SLAB TO DROP 6 INCHES FRONT

TO BACK (APPROX. 1/4" PER FOOT)

6/0 x 7/0 GARAGE DOOR

6'-0"

A3-1

SCALE: 1/4" = 1'-0"

GARAGE PLAN

A 40-AMP MINIMUM DEDICATED BRANCH CIRCUIT AND SPACE(S) RESERVED TO PERMIT INSTALLATION OF A BRANCH CIRCUIT OVERCURRENT PROTECTIVE

PROTECTUVE DEVICE SPACE(S) RESERVED FOR FUTURE EV CHARGING AS

AUTOMATIC GARAGE DOOR AND VEHICLE GATES REQUIRE BATTERY

GARAGE DOORS SHALL HAVE A MINIMUM GAP AT BOTTOM, TOP AND SIDES OF DOORS OF 1/8"



MAS FIRE RIVER

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REMARKS	DATE		
PERMIT SUBM	PERMIT SUBMITTAL		
	12-21-21		

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DRAWN BY

GARAGE PLAN AND ELEVATIONS CLASS "A" FIBERGLASS ASPHALT ROOF SHINGLES TO BE SELECTED BY OWNER. INSTALL OVER 30# FELT PER

INSTALLATION OF ROOFING SHALL BE IN ACCORDANCE WITH MANUFACTURER'S SPECIFICATIONS.

"LEAF-GUARD" TYPE PREFINISHED METAL GUTTERS AND DOWNSPOUTS.

DOWNSPOUTS SHALL BE CONNECTED TO UNDERGROUND PLASTIC DRAINPIPES, SLOPED TO DAYLIGHT.

ROOF SHEATHING

USE MIN. 1/2" APA 32/16 PLYWOOD. NAIL PLYWOOD WITH 8d'S AT 6" O.C. AT PLYWOOD EDGES, TO BEARING WALL BLOCKING AND TO END TRUSS AT END WALLS. USE 8d'S AT 12" O.C. FIELD. USE H1 OR A35 CLIPS FOR TRUSS TO BEARING WALL CONNECTION.

FLASHING:

METAL FLASHING TO BE INCORPORATED IN VALLEYS. IT SHALL NOT BE LESS THAN NO. 26 GAUGE GALVANIZED SHEET CORROSION RESISTANT METAL INSTALLED OVER A MINIMUM 36-INCH WIDE UNDERLAYMENT CONSISTING OF NO. 72 ASTM CAP SHEET RUNNING THE FULL LENGTH OF THE VALLEY.

FRAMING NOTES:

ALL HEADERS AND BEAMS SHALL BE DF#2 UNLESS NOTED OTHERWISE AT GABLE END WALLS EXTEND SHEAR WALL TYPE AND NAILING TO ROOF SHEATHING

AT CALIFORNIA FRAMED AREAS, FULL ROOF SHEATING IS REQUIRED AT LOWER ROOF

DOUBLE STUDS USED AT HOLD DOWNS SHOULD BE NAILED TOGETHER WITH 16d AT 6" O.C. STAGGERED

ATTIC VENTILATION

ATTIC SHALL BE PROVIDED WITH A MINIMUM NET FREE VENTILATING AREA NOT LESS THAN A1/150 OF THE AREA OF THE SPACE VENTILATED

FOR ALL ENCLOSED ATTICS OR RAFTER SPACES.

THIS MINIMUM CAN BE DECREASED TO 1/300 IF EITHER

1. AT LEAST 50% AND NOT MORE THAN 80% OF THE
REQUIRED VENTILATION IS AT LEAST 3 FEET ABOVE EAVE
OR CORNICE VENTS WITH THE BALANCE OF THE
REQUIRED VENTILATION PROVIDED BY EAVE OR
CORNICE VENTS OR 2. A CLASS I OR II VAPOR
BARRIER IS INSTALLED ON THE WARM-IN-WINTER
SIDE OF THE CEILING.

FOR ALL ENCLOSED ATTICS SPACES, VENTILATION SHALL BE PROVIDED WITH FULLY COVERED METAL WIRE MESH, VENTS, OR OTHER MATERIALS THAT HAVE A MINIMUM 1/16 INCH AND MAXIMUM 1/8 INCH OPENINGS, NON-COMBUSTIBLE AND CORROSION RESISTANT. ALL OTHER VENTS IN EAVES SHALL BE LISTED/APPROVED TO RESIST THE INTRUSION OF FLAME AND BURNING EMBERS.

HOUSE ATTIC VENTILATION ANALYSIS

HOUSE ROOF AREA = APPROX. 2,018 SQ. FT. INCLUDING EAVES AND COVERED PORCH

MIN. VENTILATION AREA = 2,018 / 300 = 6.73 SQ. FT. REQUIRED = 969 SQ. IN. REQUIRED

EAVE VENTILATION:

SMARTVENT 9 SQ. IN. NFA PER FOOT x 54 FT.= 486 SQ. IN. PROVIDED

PROVIDE 54 FEET OF SMART VENT 27 FEET EACH SIDE OF ROOF

CONTIN. RIDGE VENT:

BRANDGUARD RIDGE VENT (NARROW) MODEL 00037

CONTIN. 9" WIDE RIDGE VENT - NET FREE AREA = 17.2 SQ. IN. / LIN. FT. X 28.2 LIN. FT. = 486 SQ. IN. PROVIDED

ROOF VENTILATION - TOTAL:

EAVE VENTS = 486 SQ. IN.

RIDGE VENT = 485 SQ. IN.

TOTAL VENT AREA = 971 SQ. IN.

GARAGE ATTIC VENTILATION ANALYSIS

GARAGE ROOF AREA = APPROX. 960 SQ. FT. INCLUDING EAVES AND COVERED PORCH

MIN. VENTILATION AREA = 960 / 300

= 3.2 SQ. FT. REQUIRED = 462 SQ. IN. REQUIRED

EAVE VENTILATION:

SMARTVENT

1.75" HOLES AT 3" O.C. = 2.4 SQ. IN. EACH

9 SQ. IN. NFA PER FOOT (x .75 TOTAL) = 1.8 SQ. IN EA.

DRILL 6- 1.75" RND. HOLES AT 3" O.C. AT SMART VENT

X 22 BAYS (11 EACH SIDE OF ROOF) = 238 SQ. IN. PROVIDED

PROVIDE 6 EAVE VENTS / BORE HOLES PER BAY

AT 22 TRUSS BAYS (11 EACH SIDE OF ROOF)

CONTIN. RIDGE VENT:

TOTAL VENT AREA = 470 SQ. IN.

BRANDGUARD RIDGE VENT (NARROW) MODEL 00037 CONTIN. 9" WIDE RIDGE VENT - NET FREE AREA = 17.2 SQ. IN. / LIN. FT. X 13.5 LIN. FT. = 232.2 SQ. IN. PROVIDED

ROOF VENTILATION - TOTAL:

EAVE VENTS = 238 SQ. IN.

RIDGE VENT = 232 SQ. IN.

DESIGN NOTES

TYPICAL PLATE HEIGHT = 9'-0" UNLESS OTHERWISE NOTED

ADJUST HEEL HEIGHT AT TRUSSES AS REQUIRED SUCH THAT FASCIA ALIGN - UNLESS OTHERWISE NOTED

TYPICAL OVERHANG = 24" TYPICAL / 12" AT GABLE ENDS

TRUSS PLAN NOTES

DO NOT CUT ANY LOAD BEARING TRUSS

BRACE ROOF FRAMING TO BEARING
PARTITIONS ONLY

FINAL ROOF / TRUSS LAYOUT SHALL
BE AS PER FINAL TRUSS ENGINEERING

TRUSSES / ROOF FRAMING SHALL BE PRE-

ENGINEERED AND PRE-FABRICATED. SUPPLIER
TO SUBMIT ALL CALCULATIONS AND DETAILS TO
THE BUILDING DEPARTMENT, CONTRACTOR AND
ENGINEER OF RECORD FOR APPROVAL PRIOR
TO FABRICATION

SIMPSON H1 TYPE AT EACH TRUSS TO WALL

PHOTO VOLTAIC NOTES


PV ARRAYS OCCUPYING LESS THAN 66% OF ROOF AREA REQUIRE 18" SETBACK ON BOTH SIDES OF THE RIDGE.

GARAGE ROOF PLAN

SCALE: 1/4" = 1'-0"

TRUSS AND ENGINEERING NOTE

LOADING / ENGINEERING SHALL ASSUME ROOF MOUNTED SOLAR PANELS

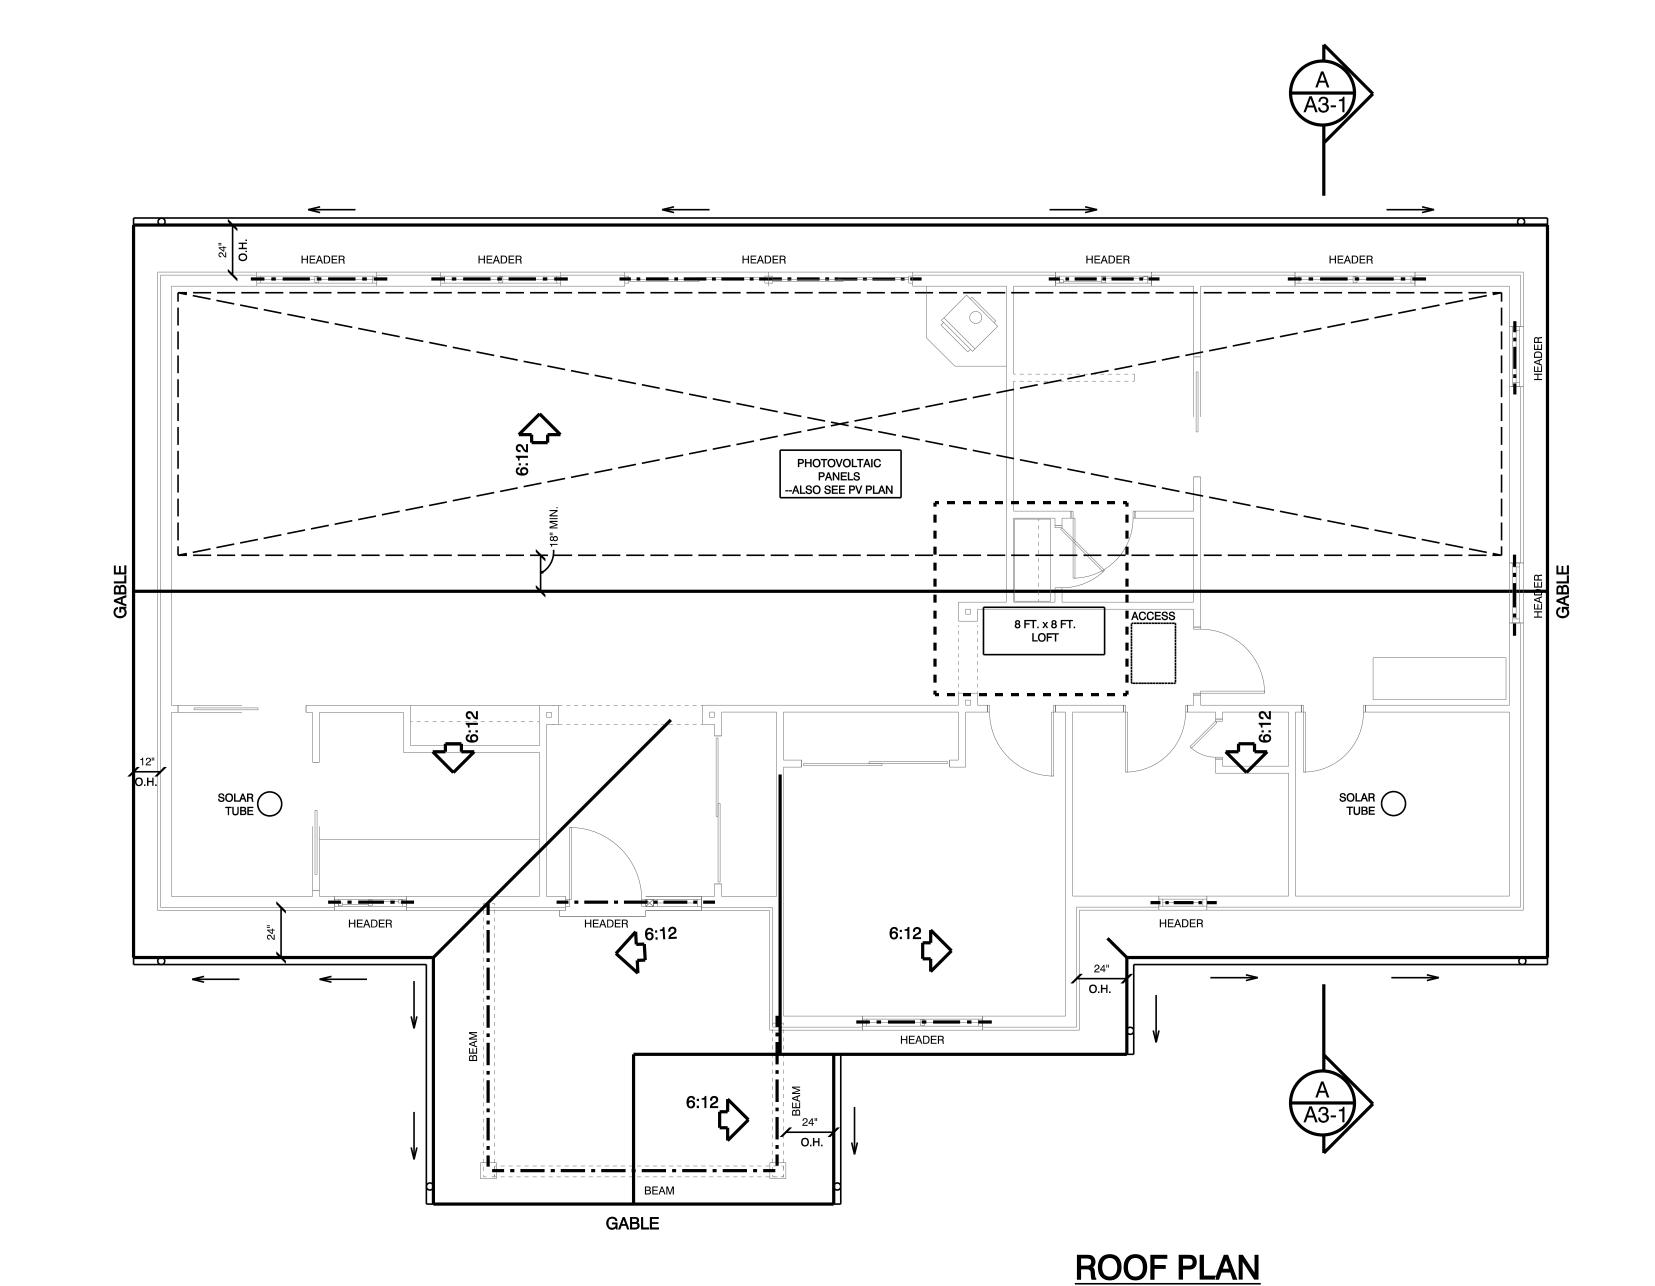

SCALE: 1/4" = 1'-0"







THE MALAKOFF HOUSE

WRITTEN DIMENSIONS ON THESE DOCUMENTS SHALL HAVE PRECEDENCE OVER SCALED DIMENSIONS.

CONTRACTORS SHALL VERIFY AND BE RESPONSIBLE FOR ALL DIMENSIONS AND CONDITIONS ON THE JOB.

REMARKS	DATE
PERMIT SUBMITTAL	
	12-21-21

ALL FIELD CHANGES TO APPROVED SET OF PLANS SHALL BE FIRST APPROVED BY THE BUILDING DEPARTMENT. FAILURE TO PROVIDE CHANGES TO THE BUILDING DEPARTMENT MAY BE CAUSE FOR THE DEPARTMENT TO ISSUE A STOP WORK NOTICE.



DWELLING & GARAGE ROOF PLANS

A1-3

EXTERIOR FINISHES

HORIZONTAL SIDING: HARDIE-PLANK (OR EQUAL) HORIZONTAL SIDING - PAINTED. INSTALL OVER TYVEK WRAP OR SIMILAR WATER RESISTIVE BARRIER PER CRC R703.2.

BOARD AND BATT SIDING: HARDIE-PLANK (OR EQUAL) BOARD AND BATT PATTERN SIDING - PAINTED. INSTALL OVER TYVEK WRAP OR SIMILAR WATER RESISTIVE BARRIER PER CRC R703.2 TRIMS, FRIEZE BOARD AND BELLY BAND: 5/4 CHOICETRIM

(OR EQUAL) TRIMS. PIERS AND POSTS AS INDICATED.

EXTERIOR WINDOW AND DOOR TRIMS: - TRADITIONAL EXTERIOR WINDOW AND DOOR TRIMS, WITH SLOPING SILL (WITH DRIP), AND APRON. - FLASHING TO LAP WINDOW AND DOOR TRIMS AT HEAD. - PRIME AND PAINT

FACIA: 5/4 CHOICETRIM (OR EQUAL) FASCIA.

POSTS: FRONT EXTERIOR POSTS TO BE CASED / TRIMMED 5/4 CHOICE-TRIM (OR EQUAL). - PRIME AND PAINT TO MATCH EXISTING STRUCTURES.

EAVES: EXPOSED EAVE WITH VENTED FRIEZE BLOCK. PRIME AND PAINT ALL SURFACES. EAVES / SOFFITS AT COVERED PORCHES:

EXPOSED EAVE WITH VENTED FRIEZE BLOCK. - T-111 (4" GROOVE) SHEATHING AS HORIZONTAL SOFFIT / - PRIME AND PAINT TO MATCH EXISTING STRUCTURES.

PRIME / PAINT ALL EXTERIOR MATERIALS: - BID TO ASSUME TWO BASE COLORS WITH SEPARATE TRIM - COLORS AS APPROVED BY OWNER. - COLORS TO MATCH COLORS OF EXISTING STRUCTURES.

EVERGRAIN DECKING, OR APPROVED EQUAL. VIEW RAILINGS: HORIZ. CABLES AT 4" O.C. MAX. - SYSTEM / TO BE SELECTED BY OWNER.

DECKS AND EXTERIOR STAIRS: CHOICEDECK OR

WINDOWS AND DOORS

PROVIDE GRID PATTERNS AS INDICATED - SEE PLANS AND ELEVATIONS.
COLOR TO BE SELECTED BY OWNER.

(OR COMPOSITE) WITH TEMPERED GLAZING.

GARAGE MAN-DOOR SHALL BE WOOD OR COMPOSITE WITH TEMPERED

FACTORY-BUILT FLUE SHALL BE INSTALLED IN STRICT ACCORDANCE WITH IT'S LISTINGS AND THE MANUFACTURER'S

GABLE END

NOTE: SIDING AT GABLE ENDS SHALL BE EITHER NON-COMBUSTIBLE MATERIAL, IGNITION RESISTANT MATERIAL, OR ONE LAYER OF 5/8" TYPE X EXTERIOR RATED GYPSUM SHEATHING APPLIED BEHIND AN EXTERIOR COVERING, OR AN ASSEMBLY APPROVED BY OSFM BML.

ROOF TO BE "CLASS A" FIBERGLASS COMPOSITION ROOF SHINGLES. MANUFACTURER AND COLOR TO BE SELECTED BY OWNER. INSTALL OVER 30# FELT UNDERLAYMENT PER CRC R905.1.1.

STANDARD PREFINISHED METAL GUTTERS AND DOWNSPOUTS. DOWNSPOUTS SHALL BE CONNECTED TO UNDERGROUND PLASTIC

DRAINPIPES, SLOPED TO DAYLIGHT. "SUN TUNNEL" SOLAR TUBES AS INDICATED

WINDOWS: HIGH QUALITY VINYL WINDOWS WITH DUAL PANE / LOW-E GLAZING.

GARAGE DOORS TO BE INSULATED METAL WITH SIMULATED PANEL LOOK. EACH GARAGE DOOR TO BE PROVIDED WITH AUTOMATIC GARAGE DOOR

FRONT DOOR ALLOWANCE: \$2,500.00


SLIDING GLASS DOORS TO BE WOOD WITH PRE-FINISHED METAL CLADDING


DOOR HARDWARE TO BE SELECTED BY OWNER. ASSUME HIGH QUALITY LEVER TYPE DOOR HARDWARE WITH RUSTIC FINISH.

INSTRUCTIONS AS SPECIFIED IN THE MECHANICAL CODE FLUE SHALL EXTEND AT LEAST 2 FT. ABOVE THE HIGHEST ELEVATION OF ANY PORTION OF THE BUILDING WITHIN 10 FT. OF THE FLUE




FOXLEY DESIGN

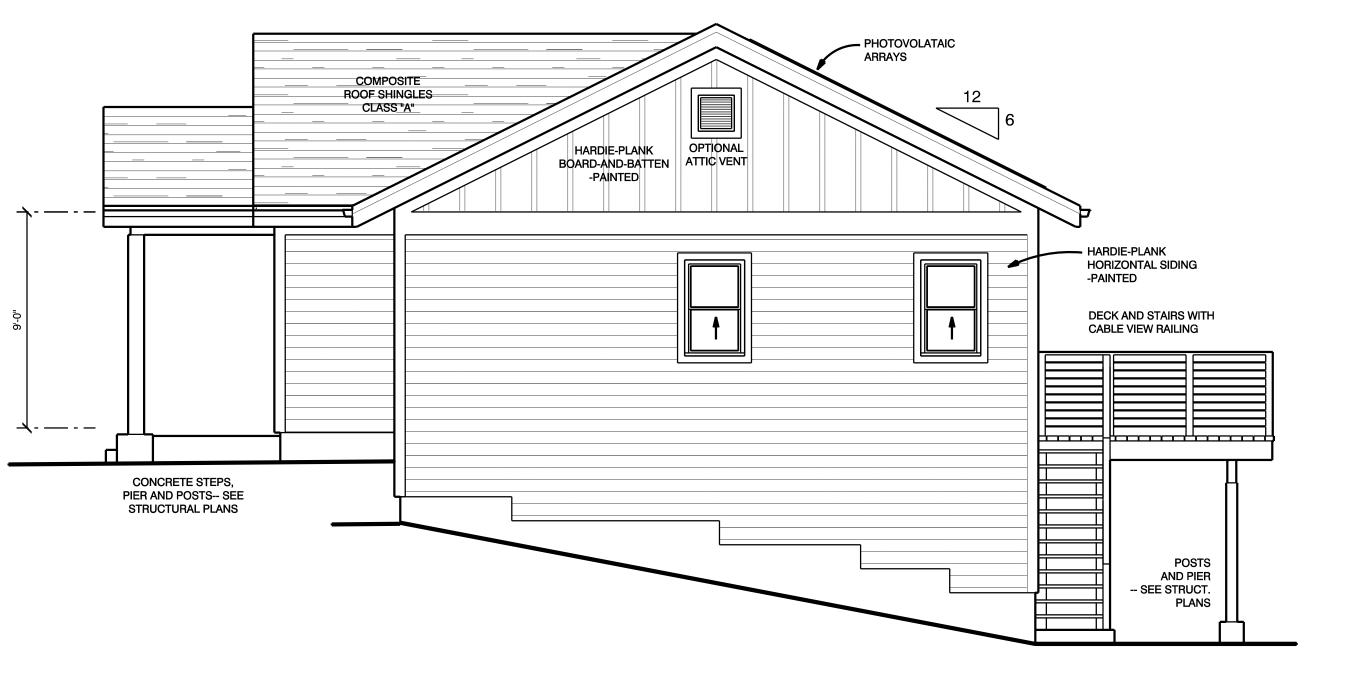


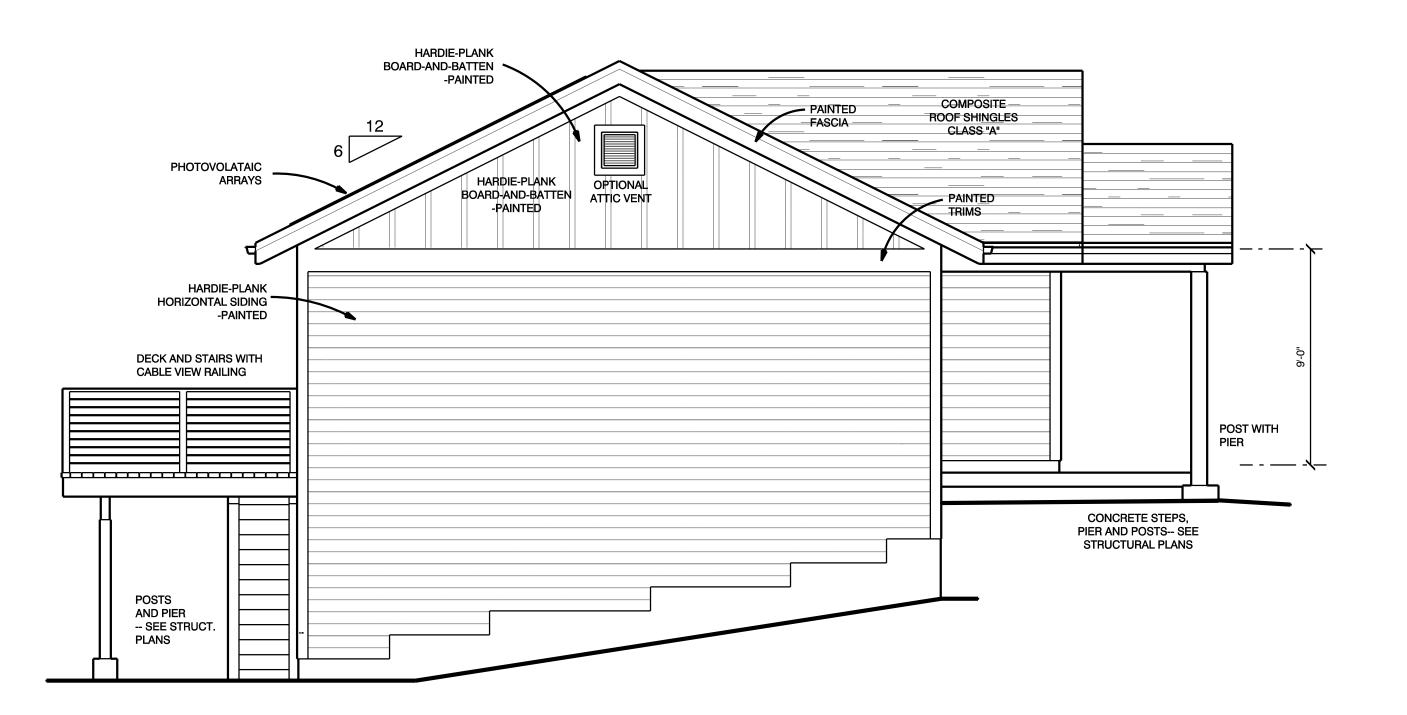

SIDE ELEVATION SCALE: 1/4" = 1'-0"

SIDE ELEVATION SCALE: 1/4" = 1'-0"

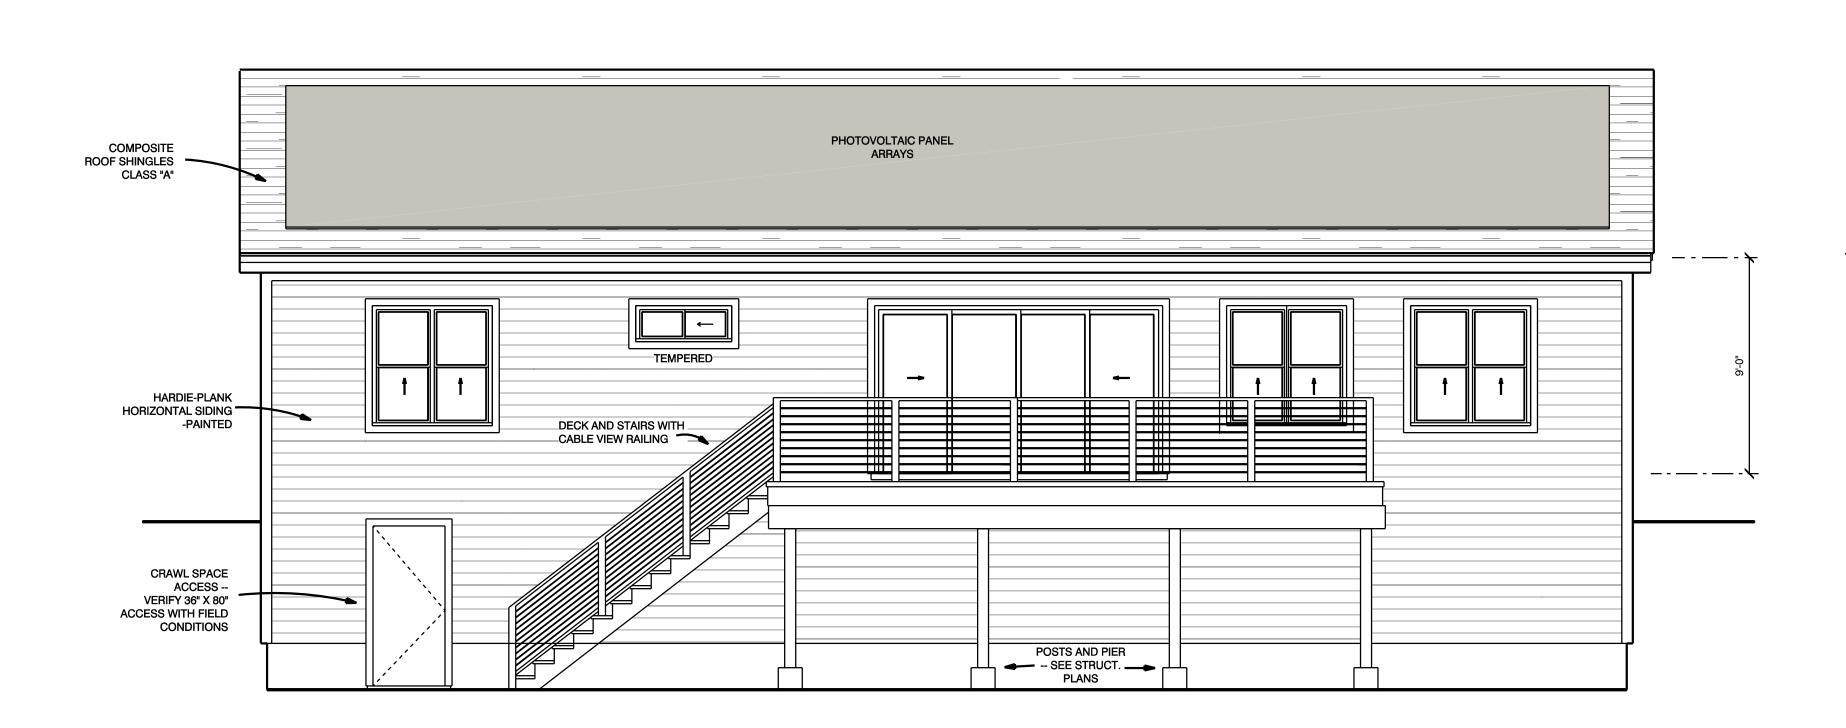

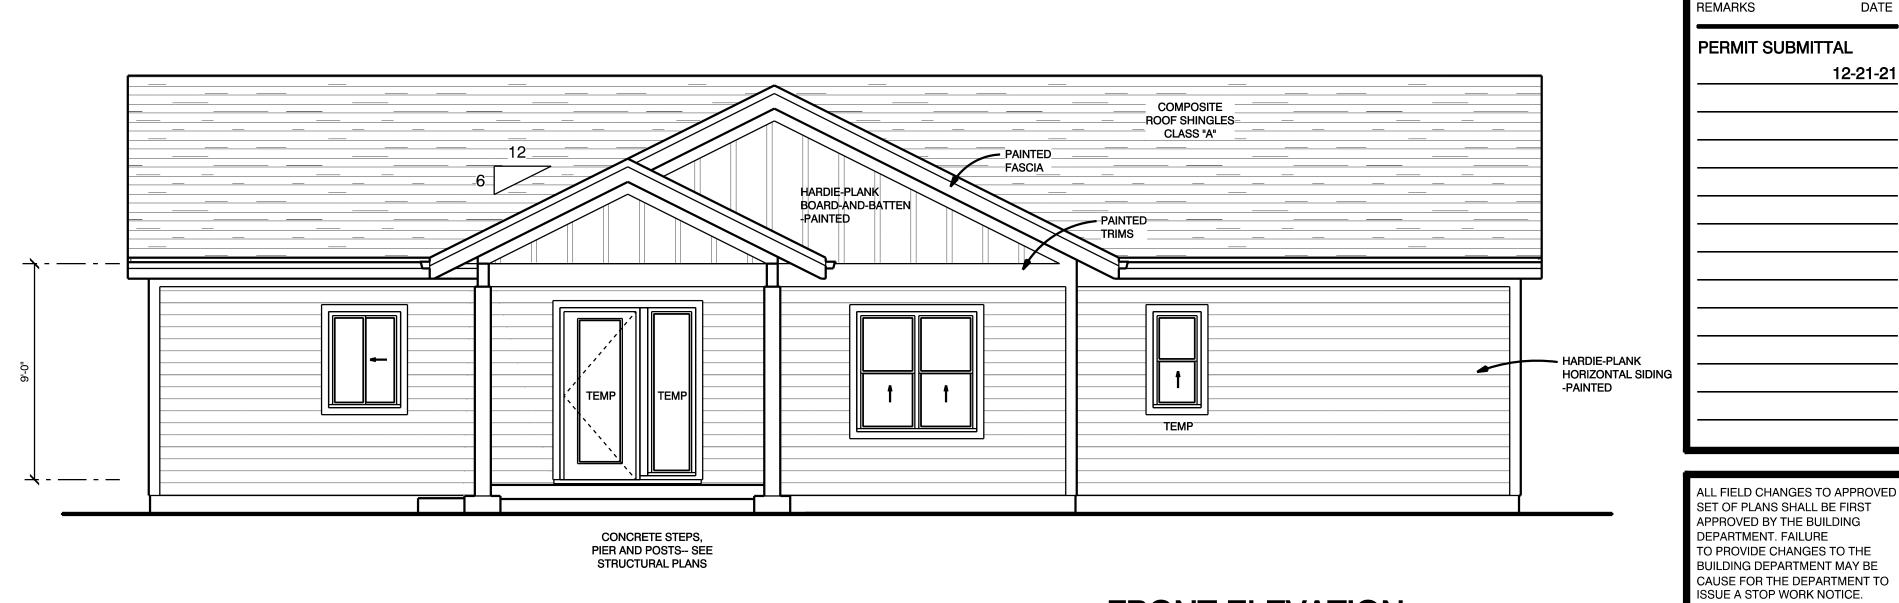

FRONT ELEVATION

SCALE: 1/4" = 1'-0"

DWELLING ELEVATIONS

DRAWN BY

Architecture

TR-Architecture.com

530.205.8750

MAST

FIRE

RIVER

WRITTEN DIMENSIONS ON THESE

CONTRACTORS SHALL VERIFY AND BE RESPONSIBLE FOR ALL DIMENSIONS AND CONDITIONS ON


DOCUMENTS SHALL HAVE PRECEDENCE OVER SCALED

PERMIT SUBMITTAL

DIMENSIONS.

REAR ELEVATION

SCALE: 1/4" = 1'-0"

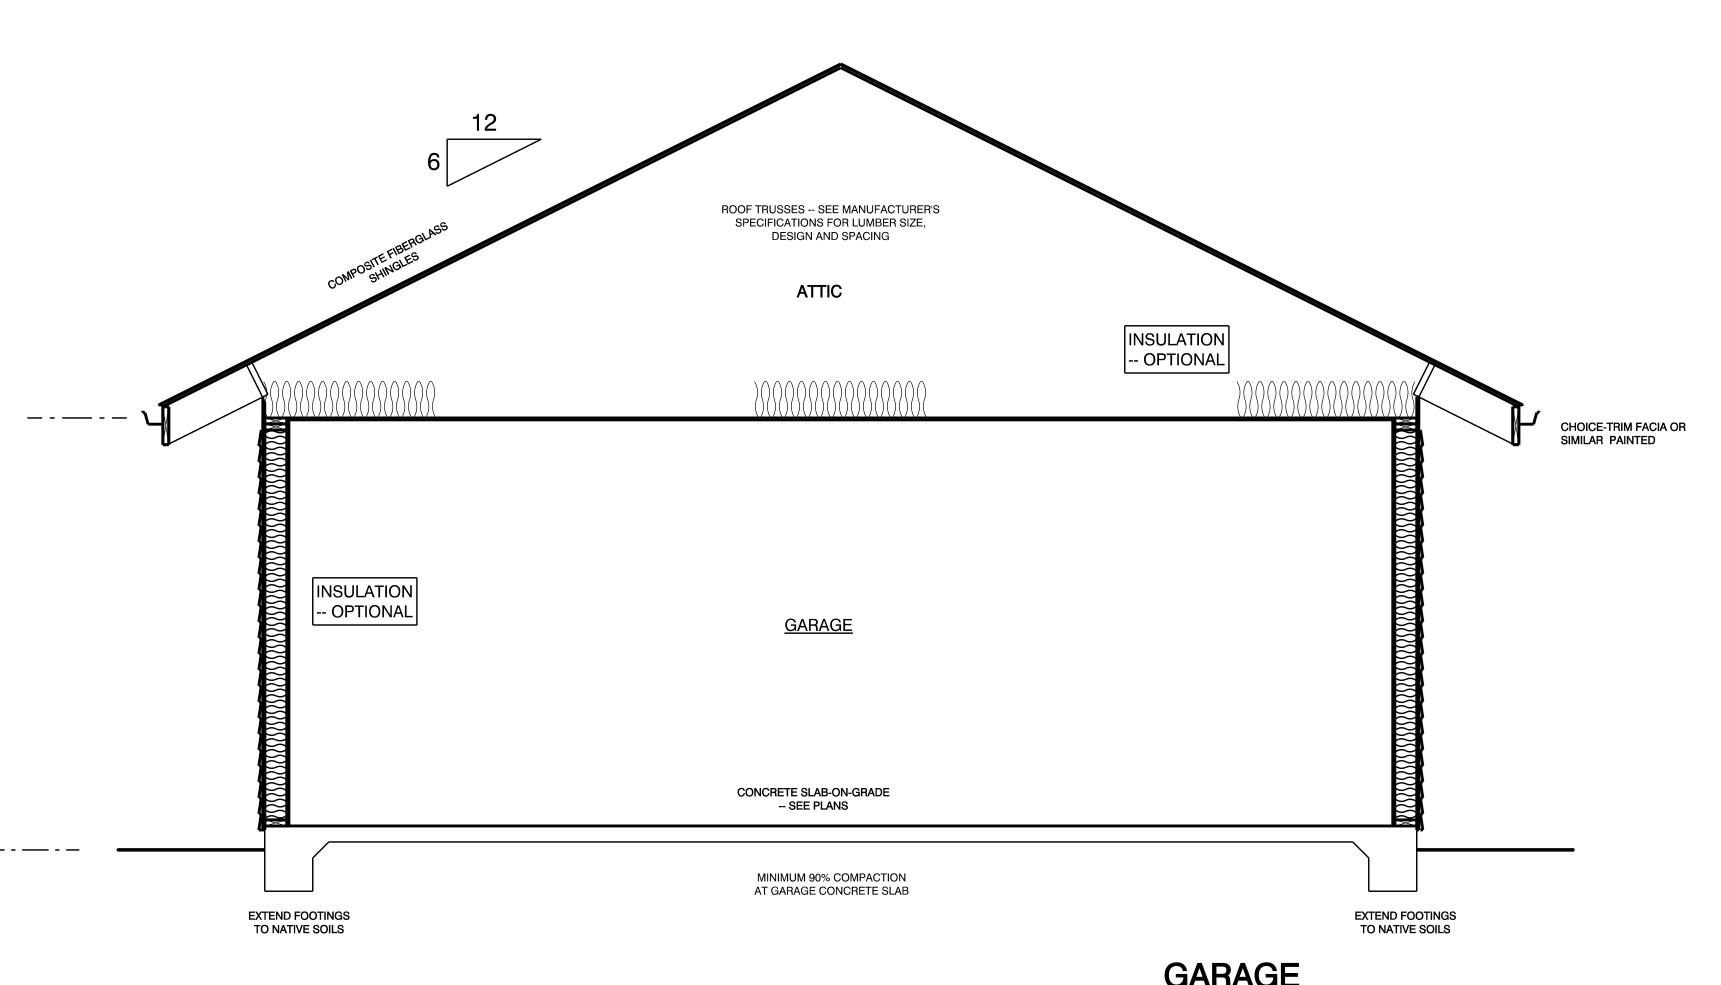

EXTERIOR WILDFIRE EXPOSURE NOTES

MATERIALS AND CONSTRUCTION IN ACCORDANCE WITH THE CURRRENT CRC

ROOFING

ROOFS SHALL COMPLY WITH THE REQUIREMENTS OF CRC. ROOFS SHALL HAVE A ROOFING ASSEMBLY INSTALLED IN ACCORDANCE WITH ITS LISTING AND THE MANUFACTURER'S INSTALLATION INSTRUCTIONS.

ROOF COVERINGS: WHERE THE ROOF PROFILE ALLOWS A SPACE BETWEEN THE ROOF COVERING AND ROOF DECKING, THE SPACES SHALL BE CONSTRUCTED TO PREVENT THE INTRUSION OF FLAMES AND EMBER, BE FIRE STOPPED WITH APPROVED MATERIALS OR HAVE ONE LAYER OF NO. 72 ASTM CAP SHEET INSTALLED OVER THE COMBUSTIBLE DECKING.

ROOF VALLEYS: WHEN PROVIDED, VALLEY FLASHINGS SHALL BE NOT LESS THAN 0.019-INCH (NO. 26 GALVANIZED SHEET GAGE) CORROSION-RESISTANT METAL INSTALLED OVER A MINIMUM 36" WIDE UNDERLAYMENT CONSISTING OF ONE LAYER OF NO. 72 ASTM CAP SHEET RUNNING THE FULL LENGTH OF THE VALLEY.

ROOF GUTTERS: ROOF GUTTERS SHALL BE PROVIDED WITH THE MEANS TO PREVENT THE ACCUMULATION OF LEAVES AND DEBRIS IN THE GUTTER.

ROOF EAVES AND SOFFITTS SHALL BE NON-COMBUSTIBLE MATERIAL, IGNITION RESISTANT MATERIAL OR ONE LAYER 5/8" TYPE X EXTERIOR-RATED GYPSUM SHEATHING APPLIED BEHIND AN EXTERIOR COVERING ON THE UNDERSIDE OF THE EAVE OR SOFFITT. (EXCEPTION: GABLE EAVE NOT REQUIRED TO BE PROTECTED)

ATTIC VENTILATION EAVE OR CORNICE VENTS: VENTS SHALL NOT BE INSTALLED IN EAVES AND

CORNICES.

VENTILATION OPENINGS SHALL BE FULLY COVERED WITH METAL WIRE MESH, VENTS, OTHER MATERIALS OR OTHER DEVICES THAT MEET THE FOLLOWING

REQUIREMENTS:

1. THE DIMENSIONS OF THE OPENINGS THEREIN SHALL BE A MINIMUM OF
1/16TH INCH (1.6 MM) AND SHALL NOT EXCEED 1/8TH INCH (3.2MM).

2. THE MATERIALS USED SHALL BE NONCOMBUSTIBLE.
EXCEPTION: VENTS LOCATED UNDER THE ROOF COVERING, ALONG THE
RIDGE OF ROOFS, WITH THE EXPOSED SURFACE OF THE VENT COVERED BY

NONCOMBUSTIBLE WIRE MESH, MAY BE OF COMBUSTIBLE MATERIALS.

EXTERIOR WALLS

EXTERIOR WALLS SHALL BE APPROVED NONCOMBUSTIBLE OR IGNITION-RESISTANT MATERIAL, HEAVY TIMBER, OR LOG WALL CONSTRUCTION OR SHALL PROVIDE PROTECTION FROM THE INTRUSION OF FLAMES AND EMBERS IN ACCORDANCE WITH STANDARD SFM 127A-1.

3. THE MATERIALS USED SHALL BE CORROSION RESISTANT.

EXTERIOR WALL COVERINGS: EXTERIOR WALL COVERINGS SHALL EXTEND FROM THE TOP OF THE FOUNDATION TO THE ROOF, AND TERMINATE AT 2" NOMINAL SOLID WOOD BLOCKING BETWEEN RAFTERS AT ALL ROOF OVERHANGS, OR IN THE CASE OF ENCLOSED EAVES, TERMINATE AT THE ENCLOSURE.

EXTERIOR GLAZING SHALL HAVE A MINIMUM OF ONE-TEMPERED PANE, GLASS BLOCK, HAVE A FIRE RESISTIVE RATING OF 20 MINUTES OR BE TESTED TO MEET PERFORMANCE REQUIREMENTS OF SFM STANDARD 12-7A-2.

EXTERIOR DOOR ASSEMBLIES: EXTERIOR DOOR ASSEMBLIES SHALL CONFORM TO THE PERFORMANCE REQUIREMENTS OF STANDARD SFM 12-7A-1 OR SHALL BE APPROVED NONCOMBUSTIBLE CONSTRUCTION, OR SOLID CORE WOOD HAVING STILES AND RAILS NOT LESS THAN 1-3/8" THICK, OR SHALL HAVE A FIRE-RESISTANCE RATING OF NOT LESS THAN 20-MINUTES WHEN TESTED ACCORDING TO ASTM E 2074. (EXCEPTION: NONCOMBUSTIBLE OR EXTERIOR FIRE-RETARDANT TREATED WOOD VEHICLE ACCESS DOORS ARE NOT REQUIRED TO COMPLY WITH THIS CHAPTER.

DECKING FLOORS AND UNDERFLOOR PROTECTION DECKING SURFACES: DECKING, SURFACES, STAIR TREADS, RISERS, AND

DECKING SURFACES: DECKING, SURFACES, STAIR TREADS, RISERS, AND LANDINGS OF DECKS, PORCHES, AND BALCONIES WHERE ANY PORTION OF SUCH SURFACE IS WITHIN 10' OF THE PRIMARY STRUCTURE SHALL COMPLY WITH ONE OF THE FOLLOWING:

SHALL BE CONSTRUCTED OF IGNITION-RESISTANT MATERIALS AND PASS THE PERFORMANCE REQUIREMENTS OF SFM 12-7A-4.

 SHALL BE CONSTRUCTED WITH HEAVY TIMBER, EXTERIOR FIRE-RETARDANT-TREATED WOOD OR APPROVED NONCOMBUSTIBLE

3. THE USE OF PAINTS, COATINGS, STAINS, OR OTHER SURFACE TREATMENTS ARE NOT AN APPROVED METHOD OF PROTECTION.

UNDERFLOOR AND APPENDAGE PROTECTION

UNDERSIDE OF APPENDAGES AND FLOOR PROJECTIONS: THE UNDERSIDE OF CANTILEVERED AND OVERHANGING APPENDAGES AND FLOOR PROJECTIONS SHALL MAINTAIN THE IGNITION-RESISTANT INTEGRITY OF EXTERIOR WALLS, OR THE PROJECTION SHALL BE ENCLOSED TO THE

UNENCLOSED UNDERFLOOR PROTECTION: BUILDINGS SHALL HAVE ALL

UNDERFLOOR AREAS ENCLOSED TO THE GRADE THE SAME AS EXTERIOR WALL REQUIREMENTS. (EXCEPTION) THE COMPLETE ENCLOSURE OF UNDER FLOOR AREAS MAY BE OMITTED WHERE THE UNDERSIDE OF ALL EXPOSED FLOORS, EXPOSED STRUCTURAL COLUMNS, BEAMS AND SUPPORTING WALLS ARE PROTECTED AS REQUIRED WITH EXTERIOR IGNITION-RESISTANT MATERIAL CONSTRUCTION OR BE HEAVY TIMBER.

EXTERIOR PORCH CEILINGS SHALL BE NON-COMBUSTIBLE MATERIAL, IGNITION RESISTANT MATERIAL, ONE LAYER OF 5/8" TYPE X EXTERIOR-RATED GYPSUM SHEATHING APPLIED BEHIND AN EXTERIOR COVERING ON THE UNDERSIDE OF

THE PORCH CEILING OR AN ASSEMBLY APPROVED BY THE OSFM BML.

DEFENSIBLE SPACE

MATERIALS.


PRIOR TO BUILDING PERMIT FINAL APPROVAL, THE PROPERTY SHALL BE IN COMPLIANCE WITH THE VEGETATION MANAGEMENT REQUIREMENTS PRESCRIBED IN CALIFORNIA FIRE CODE SECTION 4906, INCLUDING CALIFORNIA PUBLIC RESOURCES CODE 4291 OR CALIFORNIA GOVERNMENT CODE SECTION

ACCEPTABLE METHODS OF COMPLIANCE INSPECTION AND DOCUMENTATION SHALL BE DETERMINED BY THE ENFORCING AGENCY AND MAY INCLUDE ANY OF THE FOLLOWING:

- LOCAL, STATE OR FEDERAL FIRE AUTHORITY OR DESIGNEE AUTHORIZED TO ENFORCE VEGETATION MANAGEMENT REQUIREMENTS
 ENFORCING AGENCY
- 3. THIRD-PARTY INSPECTION AND CERTIFICATION AUTHORIZED TO ENFORCE VEGETATION MANAGEMENT REQUIREMENTS
 4. PROPERTY OWNER CERTIFICATION AUTHORIZED BY THE ENFORCING
- 4. PROPERTY OWNER CERTIFICATION AUTHORIZED BY THE ENFORCING AGENCY

CONTRACTOR SHALL PROVIDE AND MAINTAIN DEFENSIBLE SPACE AND FIRE BREAK PER WILDLAND-URBAN INTERFACE REQUIREMENTS AND REQUIREMENTS OF LOCAL FIRE AUTHORITY.

CONTRACTOR SHALL REMOVE AND CLEAR AWAY ALL FLAMMABLE VEGETATION OR COMBUSTIBLE GROWTH FOR 30 FEET FROM EACH SIDE OF BUILDING.

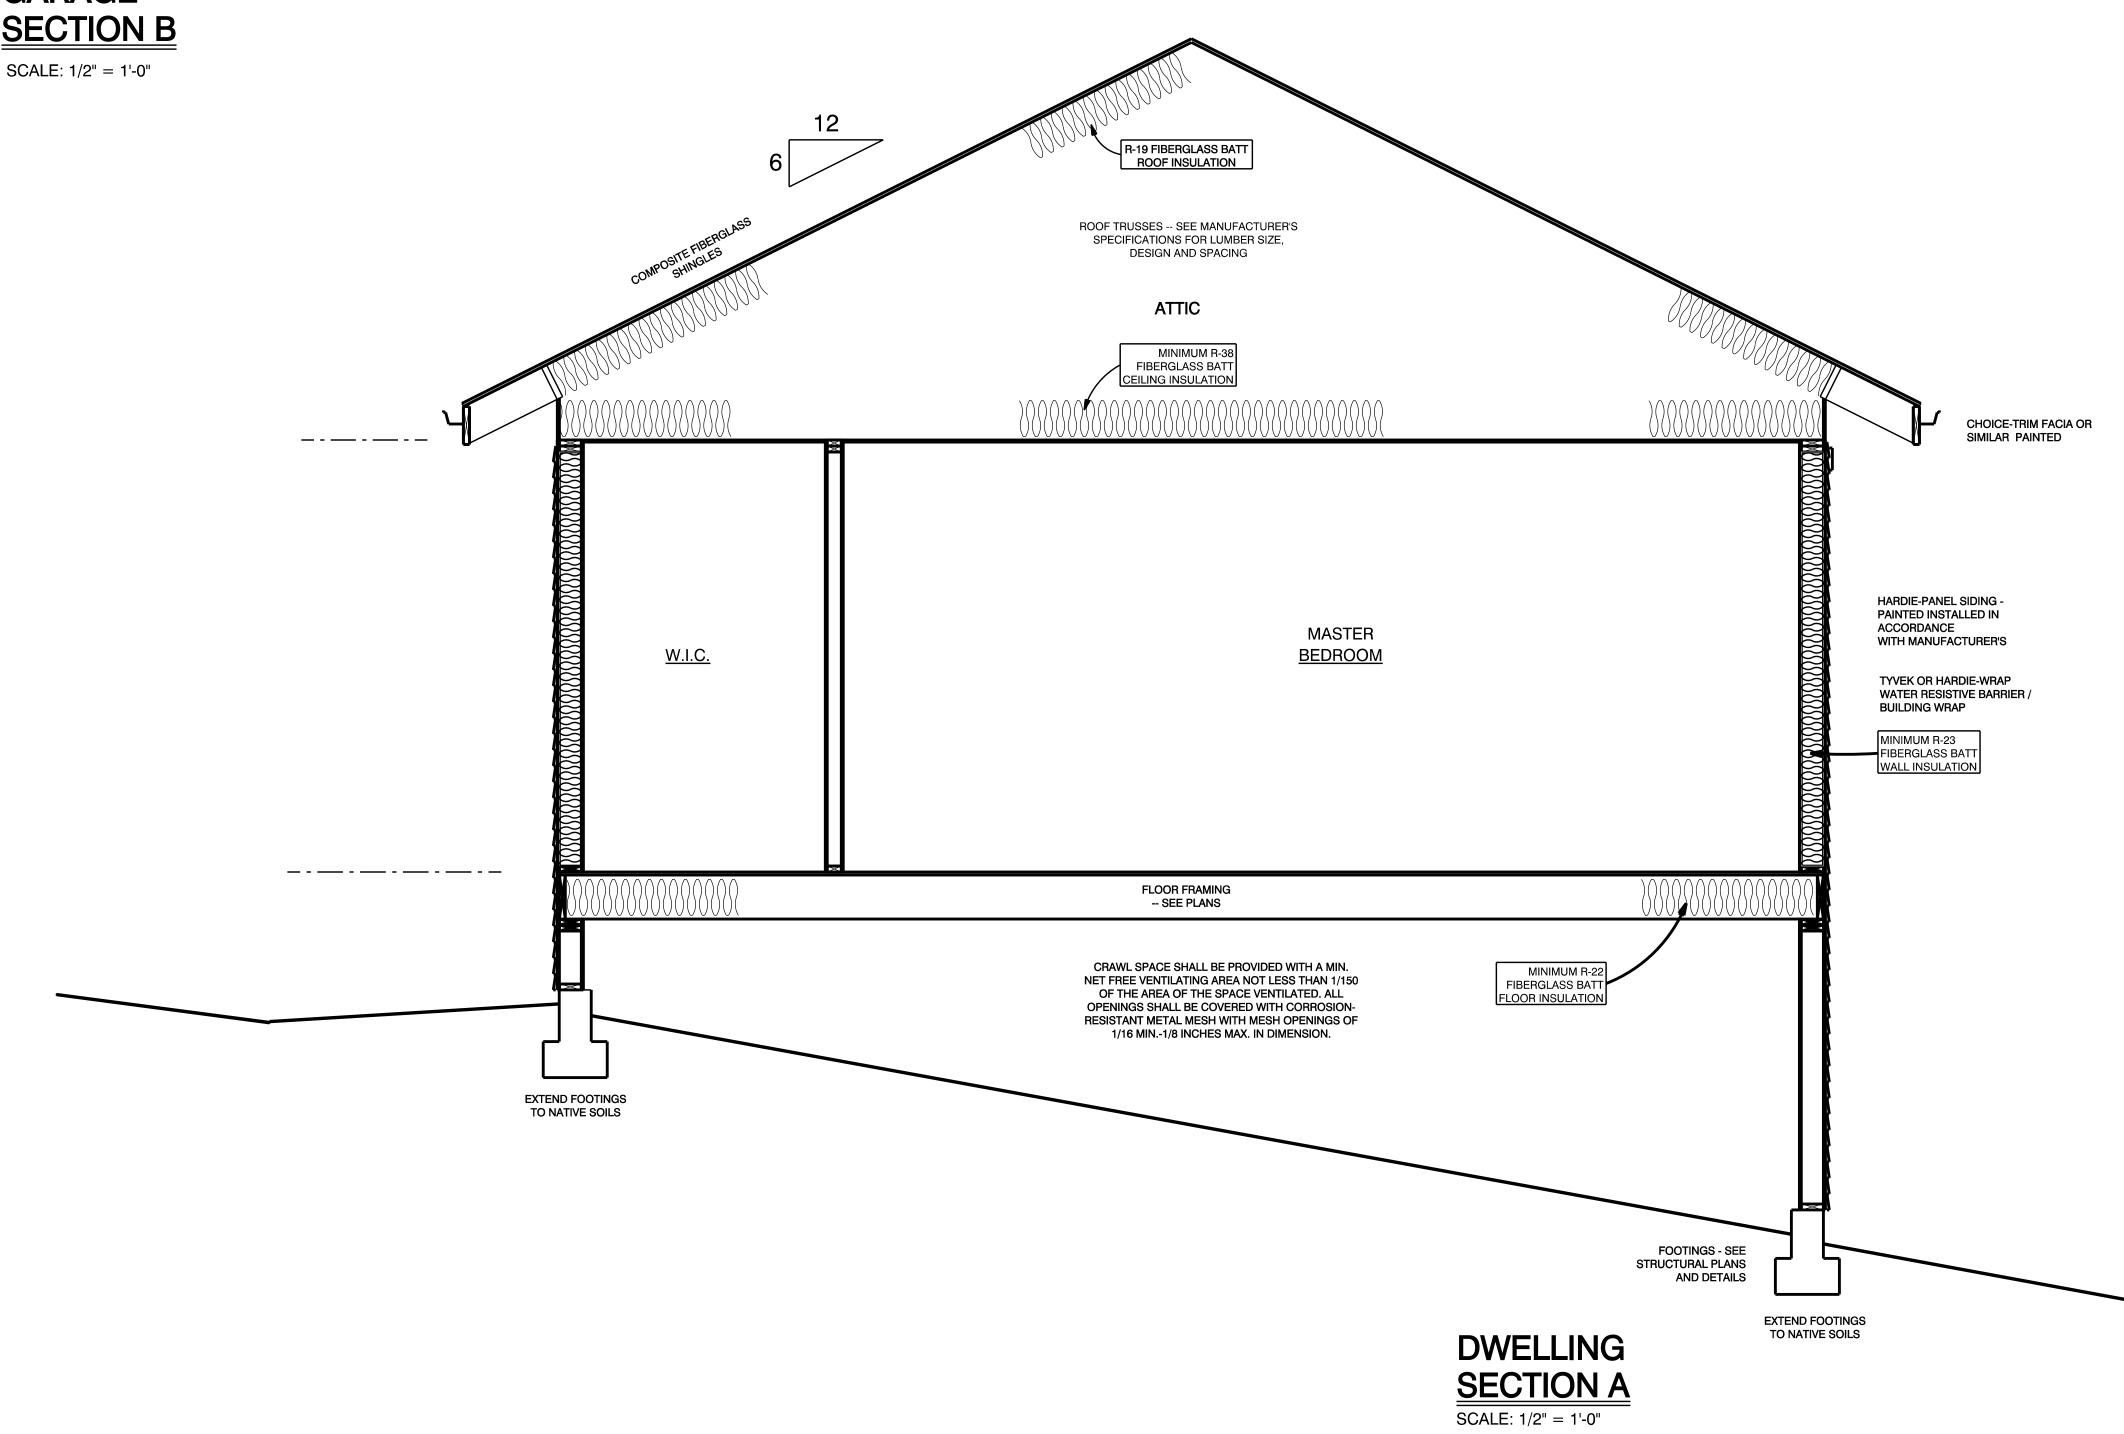







RIVER FIRE MASTER PLAN: MAI AKOFF HOFF

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CONTRACTORS SHALL VERIFY AND BE RESPONSIBLE FOR ALL DIMENSIONS AND CONDITIONS ON THE JOB.

REMARKS	DATE	
PERMIT SUBMITTAL		
	12-21-21	

APPROVED BY THE BUILDING
DEPARTMENT. FAILURE
TO PROVIDE CHANGES TO THE
BUILDING DEPARTMENT MAY BE
CAUSE FOR THE DEPARTMENT TO
ISSUE A STOP WORK NOTICE.

ALL FIELD CHANGES TO APPROVED

SET OF PLANS SHALL BE FIRST

FOLDER Malakoff
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FILE A3-1

DWELLING & GARAGE

SECTIONS

A3-1